



FINAL	PROJECT	MAY VARY
FROM	ABOVE R	ENDERING




INDEX TO DRAWINGS


	SPLASHPAD MANUFACTURER			
	INSTALLATION DETAILS			
	VOR 1004	PLAYSAFE DRAIN No. 4		
	VOR 0301	GEYSER N°1		
	VOR 0303	ROOSTER TRAIL		
	VOR 0322	WATER BLOOM N°1		
	VOR 0325	JET STREAM N°2		
	VOR 0328	TEAM SPRAY N°3		
	VOR 7010	WATER JELLY N°1		
	VOR 7249	CASCADE RIVER		
	VOR 7258	HELICO BIRDS		
	VOR 7516	SPLIT STREAM		
	VOR 7799	SPIROO		
	VOR 33907	MAESTRO PRO CONTROLLER		
	VOR55000.0430	SAFESWAP N°1		
_	VOR55000.0570	SAFESWAP N°2		



CIVIL ENGINEER: PARKITECTURE + PLANNING 901 DEMING WAY, SUITE 201 MADISON, WI 53717 608.203.8203

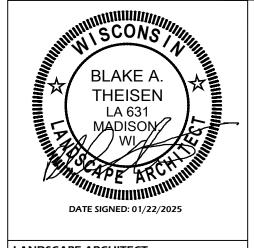

LANDSCAPE ARCHITECT: PARKITECTURE + PLANNING 901 DEMING WAY, SUITE 201 MADISON, WI 53717 608.203.8203

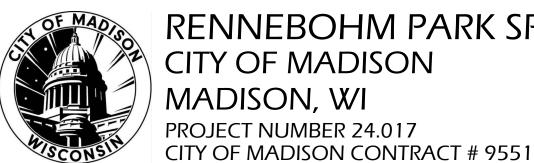

RENNEBOHM PARK SPRAYGROUND CITY OF MADISON MADISON, WI PROJECT NUMBER 24.017




RENNEBOHM PARK SPRAYGROUND 115 N. Eau Claire Avenue Madison, WI 53705


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Bidding 1/22/25







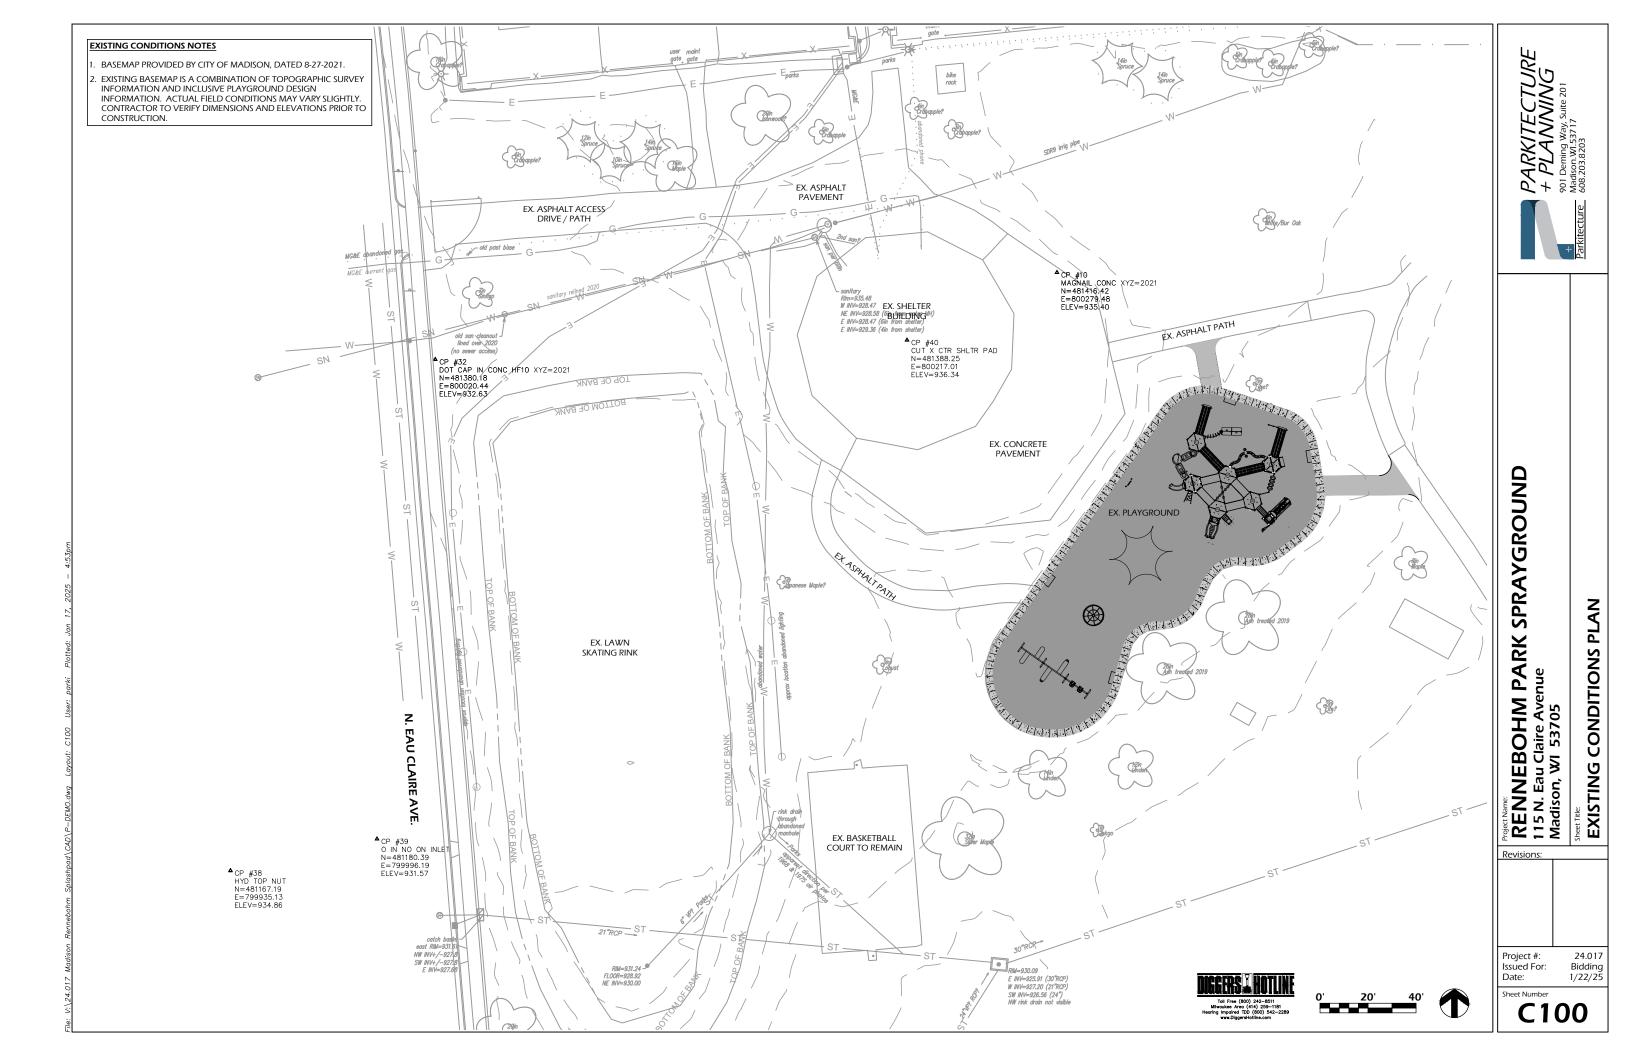

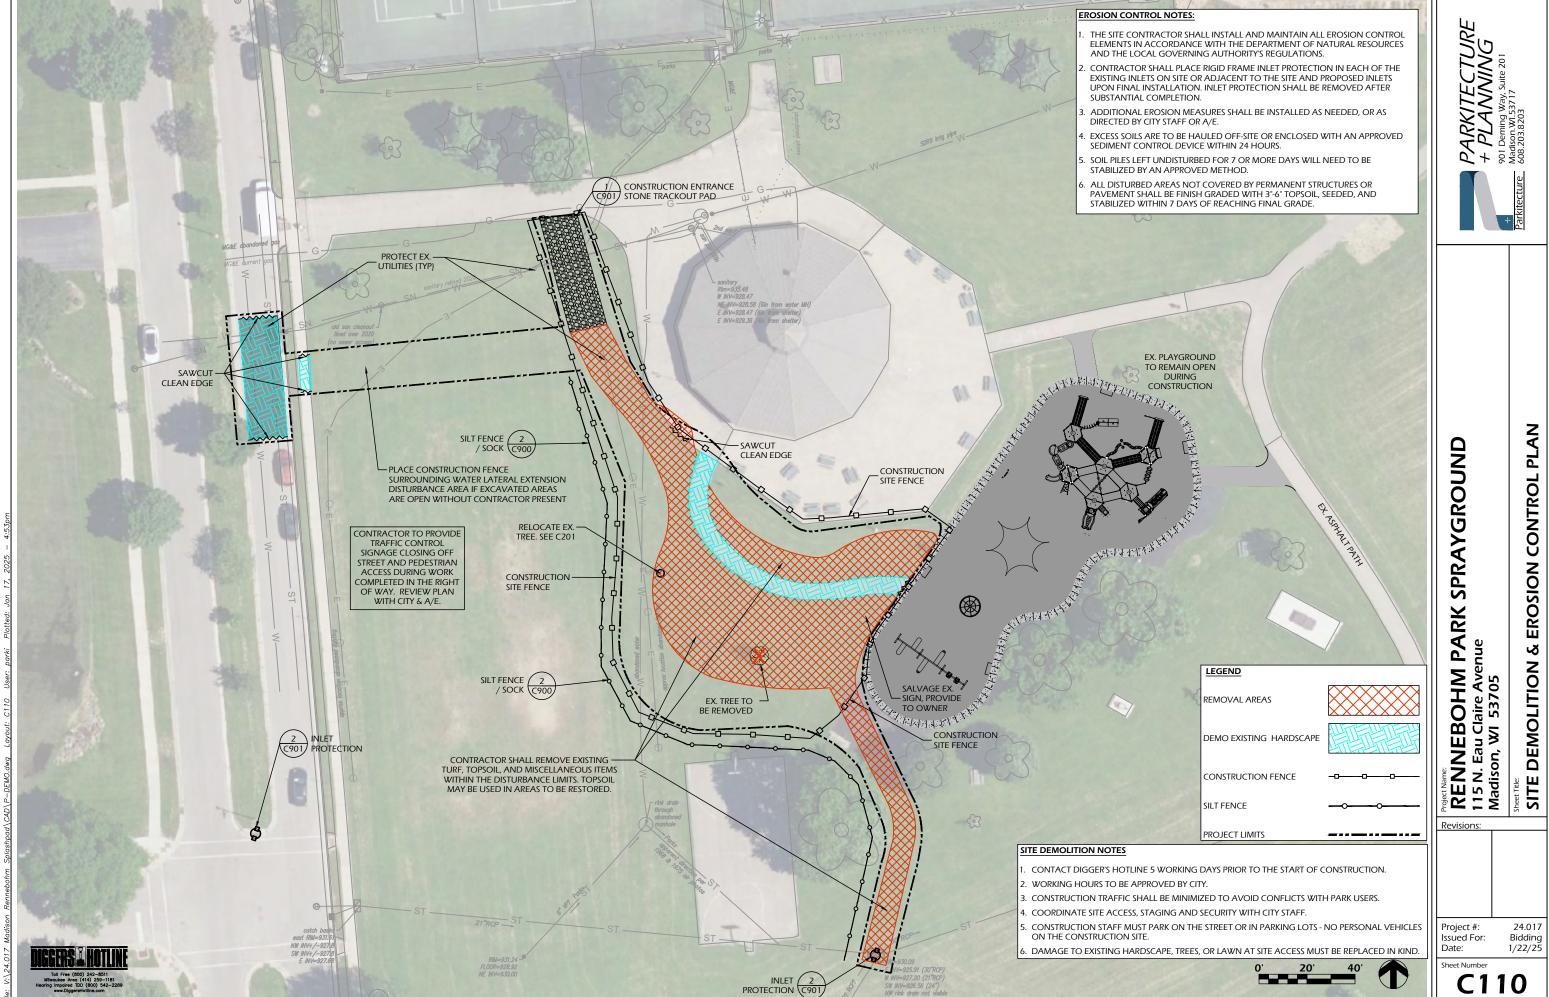











RENNEBOHM PARK SPRAYGROUND 115 N. Eau Claire Avenue Madison, WI 53705


EXISTING SITE PHOTOS

24.017 Bidding 1/22/25

Project #: 24.0 Issued For: Biddi Date: 1/22/ Sheet Number

SITE LAYOUT NOTES

- CONTACT DIGGER'S HOTLINE 5 WORKING DAYS PRIOR TO THE START OF CONSTRUCTION.
- ALL PROPOSED DIMENSIONS ARE REFERENCED PARALLEL OR PERPENDICULAR TO THE PROPOSED FEATURES SHOWN. WRITTEN DIMENSIONS SUPERSEDE ANY
- PROPOSED GRADE AND LEVEL SHALL BE PERIODICALLY REVIEWED IN THE FIELD BY THE OWNER OR A/E.
- CONCRETE JOINTING IS SHOWN FOR DESIGN INTENT. FINAL SCORING PLANS SHALL BE SUBMITTED TO THE A/E FOR REVIEW AS A SHOP SUBMITTAL.
- ALL CONCRETE POURS SHALL BE DOWELED TOGETHER UNLESS OTHERWISE APPROVED BY THE A/E.
- CONTRACTOR SHALL BE RESPONSIBLE FOR SITE STAKING. DIGITAL PLAN FILES MAY BE AVAILABLE FROM THE A/E.

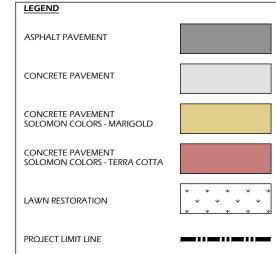

LANDSCAPE AND RESTORATION NOTES

- CONTRACTOR SHALL MEET EXISTING GRADE AT GRADING LIMITS WITH A SMOOTH AND CONTINUOUS TRANSITION.
- RESTORE ALL DISTURBED AREAS WITHIN THE PROJECT LIMITS WITH A MINIMUM 4" TOPSOIL DEPTH AND SEED. WATERING SHALL BE INCIDENTAL.
- SOD/SEED/SOIL PLACEMENT SHALL EXTEND TO THE LIMITS OF CONSTRUCTION DISTURBANCE. DISTURBANCE AREAS OUTSIDE OF THE DEFINED PROJECT LIMITS MAY BE RESTORED WITH SEED, FERTILIZER, AND CRIMP MULCH IN LIEU OF SEED/MATTING AT THE OWNER'S DISCRETION.
- ALL DISTURBED AREAS SHALL RECEIVE CLASS I URBAN TYPE A EROSION CONTROL MATTING.
- REFER TO CITY OF MADISON STANDARD SPECIFICATIONS ARTICLE 207 FOR SEED MIXTURE AND APPLICATION RATES.

RENNEBOHM PARK SPRAYGROUND 115 N. Eau Claire Avenue Madison, WI 53705

PLAN

SITE LAYOUT & RESTORATION


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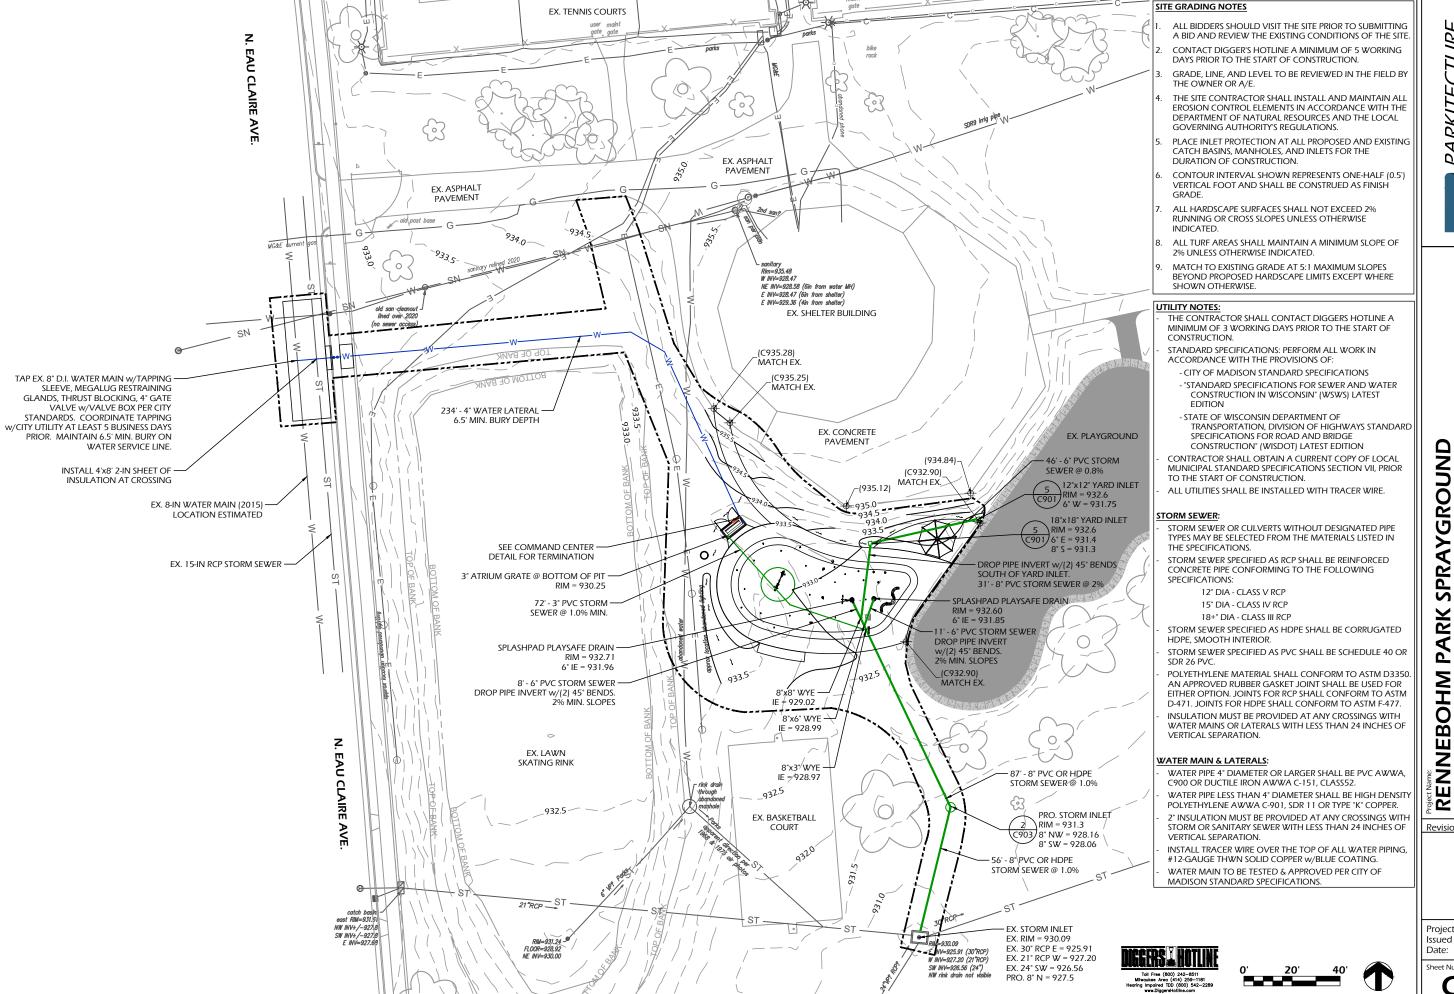
Project #: Bidding 1/22/25 Issued For:

24.017

Sheet Number **C200**

Date:



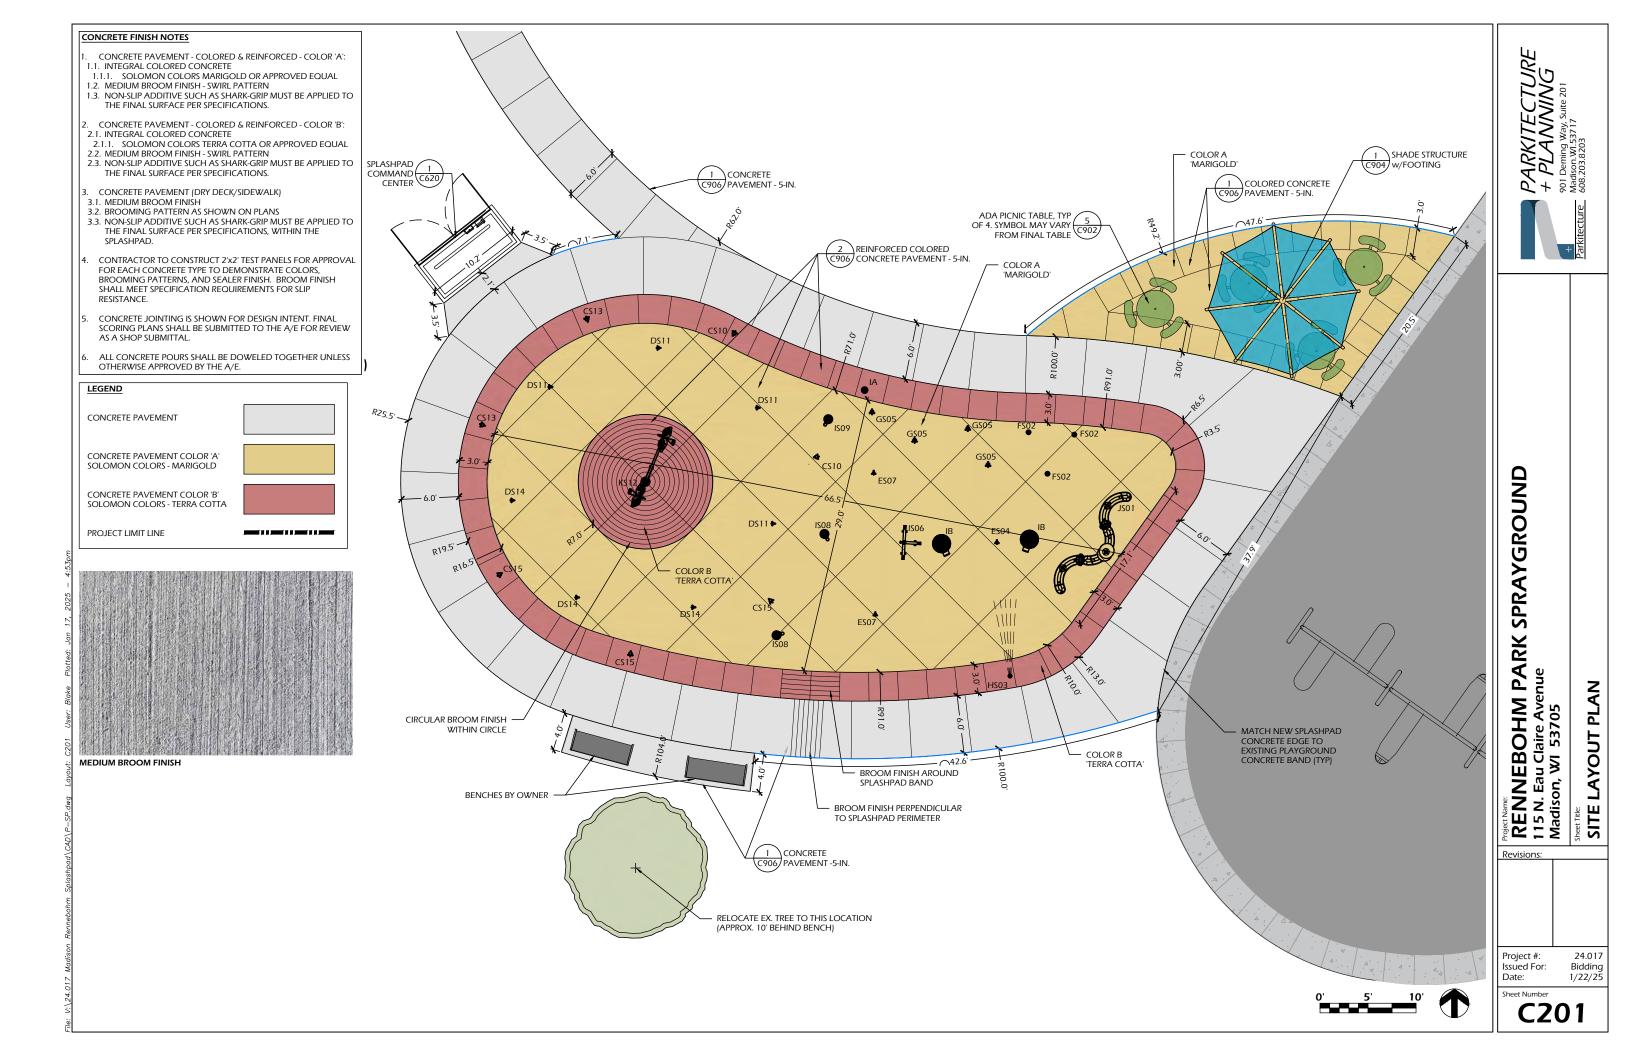



SPRAYGROUN PARK

Ū N N RENNE 115 N. Eau Madison, V PLAN

UTILITY

+

GRADING SITE

Revisions

Project #: Issued For:


Sheet Number

C400

24.017

Bidding


1/22/25

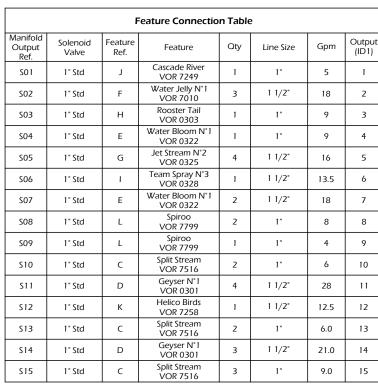

FEATURE REFERENCE LEGEND		
<u>A</u> S01	FEATURE NAME REFERENCE	
A <u>SO1</u>	MANIFOLD LINE NUMBER	

SPLASHPAD INFORMATION		
WET DECK AREA (SF)	2400	
TOTAL FEATURE FLOW RATE (GPM)	183	
AVERAGE SEQUENCED FLOW RATE (GPM)	110	

Product Legend		
Product Ref.	Product	Qty
IA	Activator N°4 VOR 0622	1
IB	Playsafe Drain N°4 VOR1004	2
IC	Water Distribution System ECCC 2.0 Cabinet Command Center	1
ID1	MaestroPRO Controller 24 out/ 12 in VOR-33907.3200	1
ID2	MaestroPRO Power Box VOR-33907.3200	1
∑ ₩•	4" Pressure Regulator	1
Z	4" Backflow Preventer	1
₹.	1" Solenoid Valve with Ball Valve & Union	15

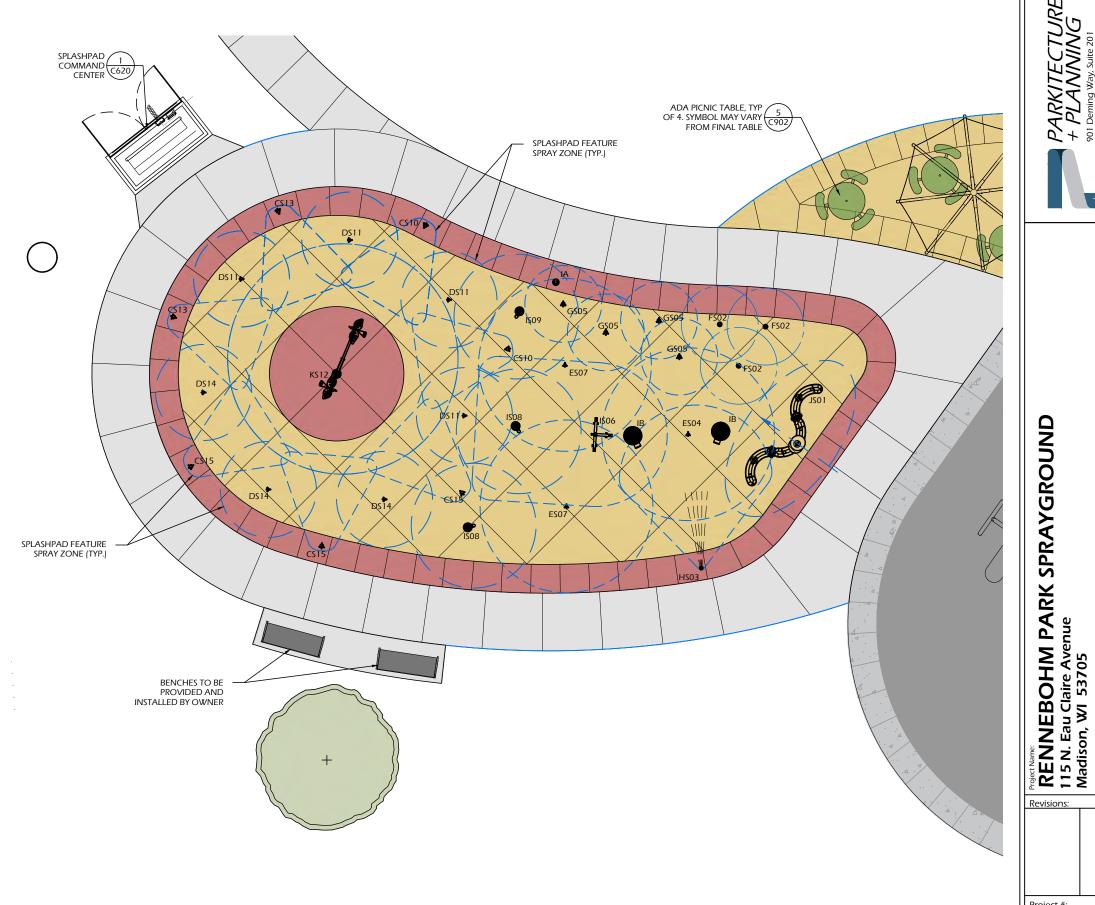





24.017


SPLASHPAD FEATURES PLAN

PARKITECTURE + PLANNING 901 Deming Way, Suite 201 Madison.WI.53717 608.203.8203

Project #: Issued For: Date:

Sheet Number **C500**

Bidding 1/22/25

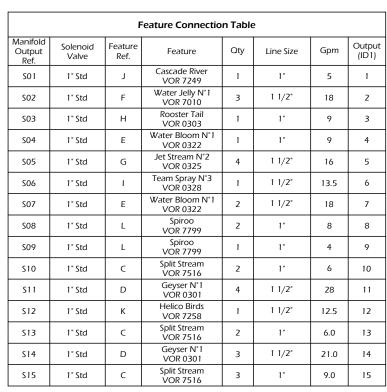


FEATU	RE REFERENCE LEGEND
A S01	FEATURE NAME REFERENCE

NCE A**S01** MANIFOLD LINE NUMBER

SPLASHPAD INFORMATION		
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ID2	MaestroPRO Power Box VOR-33907.3200	1
∑ ₩•	4" Pressure Regulator	1
Z	4" Backflow Preventer	1
₹-	1" Solenoid Valve with Ball Valve & Union	15



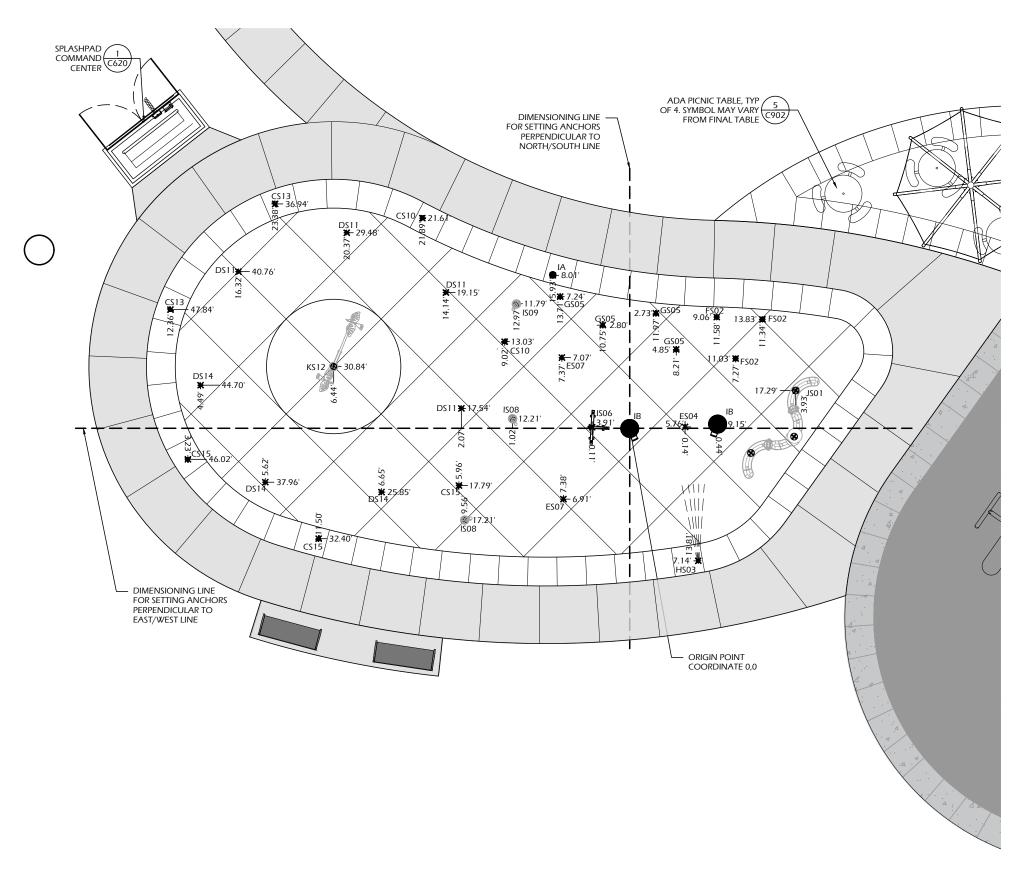

RENNEBOHM PARK SPRAYGROUND 115 N. Eau Claire Avenue Madison, WI 53705 SPLASHPAD FEATURE LAYOUT PLAN

Project #: Issued For: Date:

24.017

Bidding 1/22/25

Sheet Number C510

Feature Connection Table			
Manifold Output Ref.	Feature Ref.	Feature	Oty
SO1	J	Cascade River VOR 7249	1
S02	F	Water Jelly N°1 VOR 7010	3
S03	Н	Rooster Tail VOR 0303	1
S0 4	Е	Water Bloom N°1 VOR 0322	1
S05	G	Jet Stream N°2 VOR 0325	4
506	I	Team Spray N°3 VOR 0328	1
S07	Е	Water Bloom N°1 VOR 0322	2
802	L	Spiroo VOR 7799	2
S09	L	Spiroo VOR 7799	1
S10	С	Split Stream VOR 7516	2
S11	D	Geyser N°1 VOR 0301	4
S12	К	Helico Birds VOR 7258	1
S13	С	Split Stream VOR 7516	2
S14	D	Geyser N°1 VOR 0301	3
S15	С	Split Stream VOR 7516	3

Product Legend		
Product Ref.	Product	Qty
IA	Activator N°4 VOR 0622	1
IB	Playsafe Drain №4 VOR1004	2
IC	Water Distribution System ECCC 2.0 Cabinet Command Center	1
ID1	MaestroPRO Controller 24 out/ 12 in VOR-33907.3200	1
ID2	MaestroPRO Power Box VOR-33907.3200	1
∑ ₩•	4" Pressure Regulator	1
Z	4" Backflow Preventer	1
X	1" Solenoid Valve with Ball Valve & Union	15

SPLASHPAD INFORMATION		
WET DECK AREA (SF)	2400	
TOTAL FEATURE FLOW RATE (GPM)	183	
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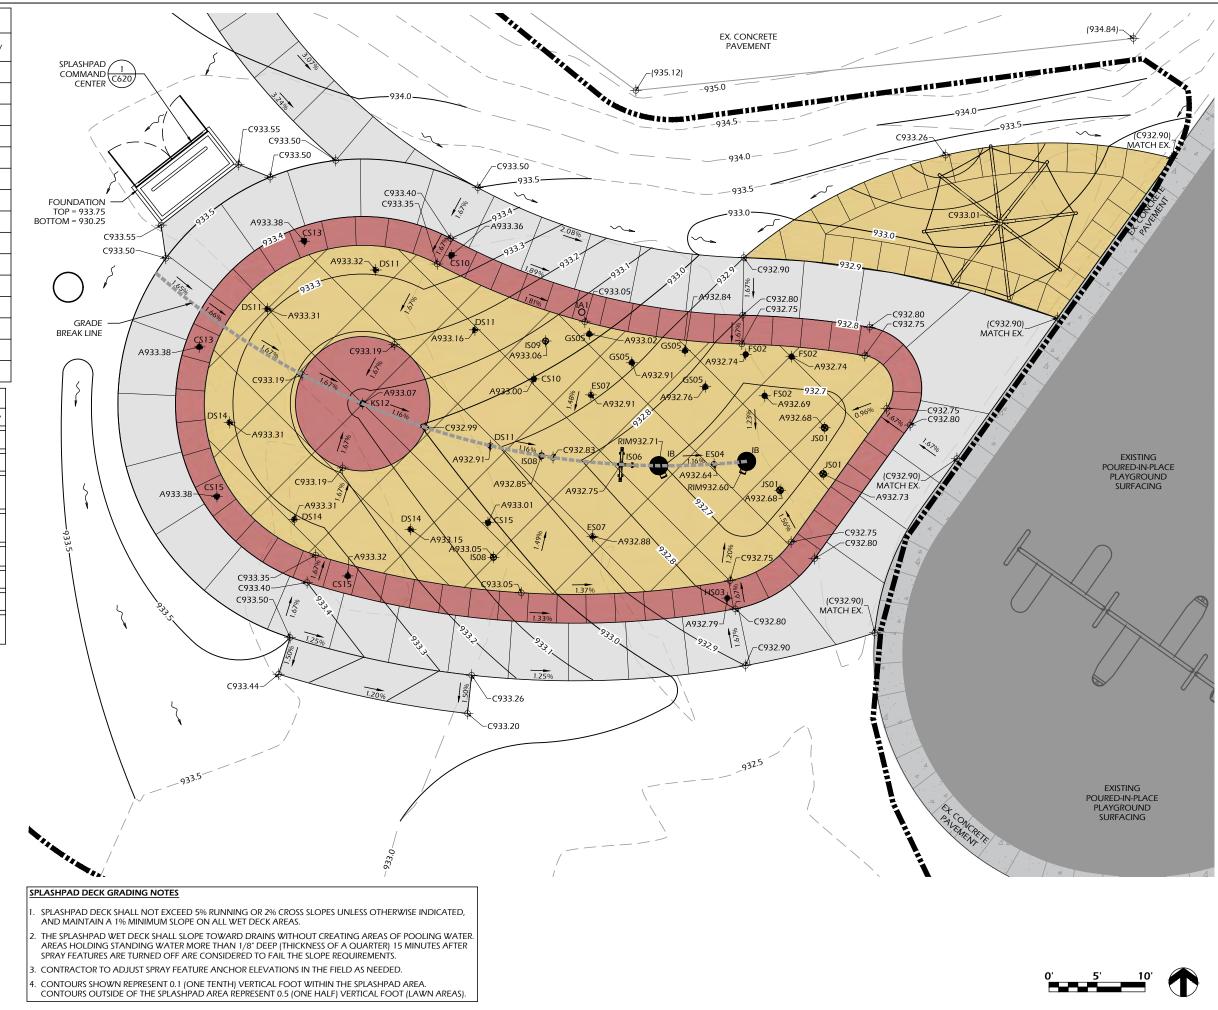
FEATURE REFERENCE LEGEND

AS01 FEATURE NAME REFERENCE AS01 MANIFOLD LINE NUMBER

SPOT GRADE ABBREVIATIONS:

= EXISTING GRADE = PROPOSED CONCRETE Cxxx.xx = ANCHOR FINISH ELEVATION Axxx.xx

SPLASHPAD DECK GRADING NOTES = PROPOSED FINISH SURFACE RIMxxx.xx = RIM ELEVATION





SPRAYGROUND

GRADING PLAN SPLASHPAD


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24.017

Project #: Issued For: Date:

Bidding 1/22/25 Sheet Number

C520

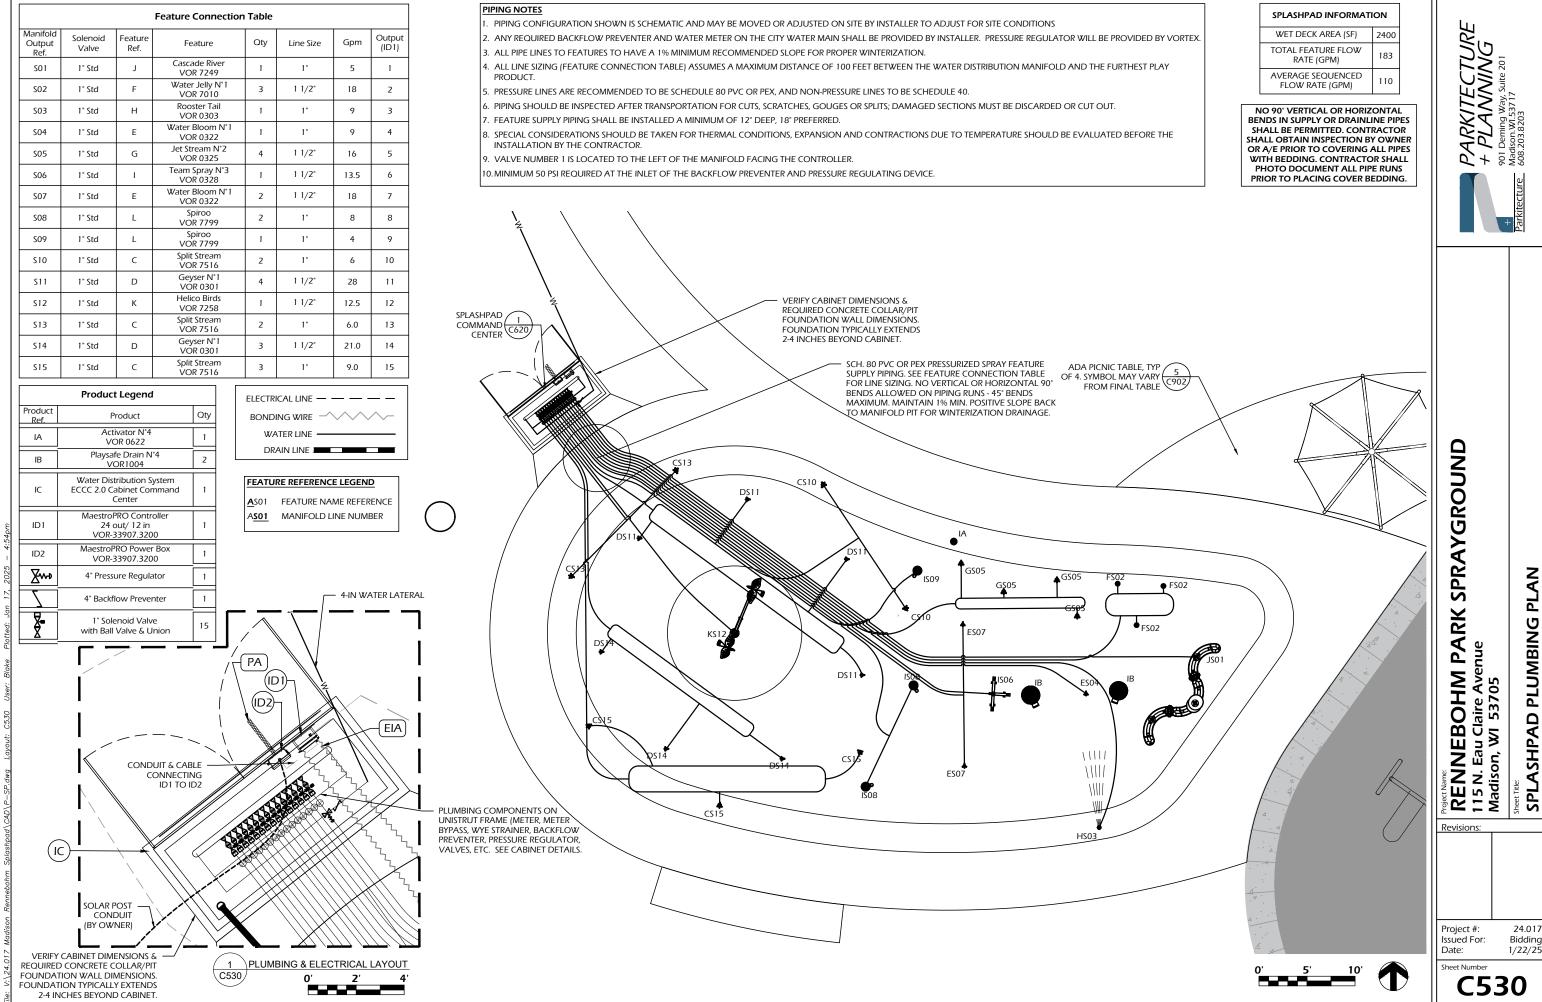

SPLASHPAD

		F	eature Connection	Table				_
Manifold Output Ref.	Solenoid Valve	Feature Ref.	Feature	Qty	Line Size	Gpm	Output (ID1)	Pro
SO1	1" Std	J	Cascade River VOR 7249	1	1"	5	1	
S02	1" Std	F	Water Jelly N°1 VOR 7010	3	1 1/2"	18	2	늗
S03	1" Std	Н	Rooster Tail VOR 0303	1	1"	9	3	Pr
S04	1" Std	Е	Water Bloom N°1 VOR 0322	1	1"	9	4	
S05	1" Std	G	Jet Stream N°2 VOR 0325	4	1 1/2"	16	5	
S06	1" Std	I	Team Spray N°3 VOR 0328	1	1 1/2"	13.5	6	l
S07	1" Std	Е	Water Bloom N°1 VOR 0322	2	1 1/2"	18	7	
808	1" Std	L	Spiroo VOR 7799	2	1"	8	8	
S09	1" Std	L	Spiroo VOR 7799	1	1"	4	9	
\$10	1" Std	С	Split Stream VOR 7516	2	1"	6	10	co
S11	1" Std	D	Geyser N°1 VOR 0301	4	1 1/2"	28	11	C
S12	1" Std	К	Helico Birds VOR 7258	1	1 1/2"	12.5	12	
\$13	1" Std	С	Split Stream VOR 7516	2	1"	6.0	13	
S14	1" Std	D	Geyser N°1 VOR 0301	3	1 1/2"	21.0	14	[
S15	1" Std	С	Split Stream VOR 7516	3	1"	9.0	15	$] \setminus$

	Product Legend	
Product Ref.	Product	Oty
IA	Activator N°4 VOR 0622	1
IB	Playsafe Drain N°4 VOR1004	2
IC	Water Distribution System ECCC 2.0 Cabinet Command Center	1
ID1	MaestroPRO Controller 24 out/ 12 in VOR-33907.3200	1
ID2	MaestroPRO Power Box VOR-33907.3200	1
∑ ₩•	4" Pressure Regulator	1
\Box	4" Backflow Preventer	1
₹-	1" Solenoid Valve with Ball Valve & Union	15

ELECTRICAL LINE — — — —
BONDING WIRE
WATER LINE ————
DRAIN LINE

FEATURE REFERENCE LEGEND **A**S01 FEATURE NAME REFERENCE ASO1 MANIFOLD LINE NUMBER


SPLASHPAD INFORMAT	ION
WET DECK AREA (SF)	2400
TOTAL FEATURE FLOW RATE (GPM)	183
AVERAGE SEQUENCED FLOW RATE (GPM)	110

ELECTRICAL NOTES

- WIRING FROM THE CONTROLLER TO EACH ACTIVATOR SHALL BE #22 AWG. A TOTAL OF FIVE (5) CONDUCTORS PER ACTIVATOR.CABLE LENGTH UP TO 246', PROVIDED BY MANUFACTURER.
- ALL CONNECTIONS TO THE CONTROLLER AND OTHER MANUFACTURER ELECTRICAL PANELS SHALL BE PERFORMED USING AN APPROVED NEMA 4X CONNECTOR.
- MAIN POWER TO BE SUPPLIED AND INSTALLED BY OWNER.
- MAINTAIN A MINIMUM CLEARANCE ZONE OF 36" IN FRONT OF ELECTRICAL PANEL, UNLESS OTHERWISE REQUESTED BY LOCAL CODE.
- USE #8 BARE COPPER BONDING WIRE BETWEEN FEATURES TO A GROUNDING ROD IN THE SOIL, TIED INTO REBAR GRID, OR AS PER LOCAL CODE.
- AS PER ELECTRICAL CONSTRUCTION AND SAFETY CODES: CONTROLLER AND/OR ANY OTHER ELECTRICAL EQUIPMENT MUST BE HARD-WIRED TO A GROUND FAULT CIRCUIT INTERRUPTER (GFCI) FROM THE INPUT POWER SOURCE.
- ALL ELECTRICAL WORK SHOULD BE PERFORMED BY A LICENCED ELECTRICIAN IN ACCORDANCE TO LOCAL ELECTRICAL CONSTRUCTION AND SAFETY CODES.
- THE MAESTROPRO CONTROL PANEL IS POWERED THROUGH A MAESTROPRO POWERBOX.
- THE POWER CABLE TO MAESTROPRO POWER BOX IS SUPPLIED BY INSTALLER.
- 10. THE MAESTROPRO CONTROL PANEL INTEGRATES 24 DIGITAL OUTPUTS WITH 24 VAC AND 12 DIGITAL INPUTS.

Electrical Line Connections Power							
Product Code	From	То	# Conductors	Gauge/Type	Note		
PA	Main Power Line (by Owner)	ID2- 120VAC	3	BY CITY, PER LOCAL CODE	120V, 1 Phase, 60Hz, 10Amps Breaker Recommended ± 5% Voltage Drop is Acceptable		

	Electrical Line Connections Controller Inputs								
Product Code	From	То	# Conductors	Gauge/ Type	Note				
EIA	ID1-Input 1	IA	2	22	Activator No 4 24 VDC, Max 345 mA, Max 300' (100m) Long (INSTALLED BY CONTRACTOR)				

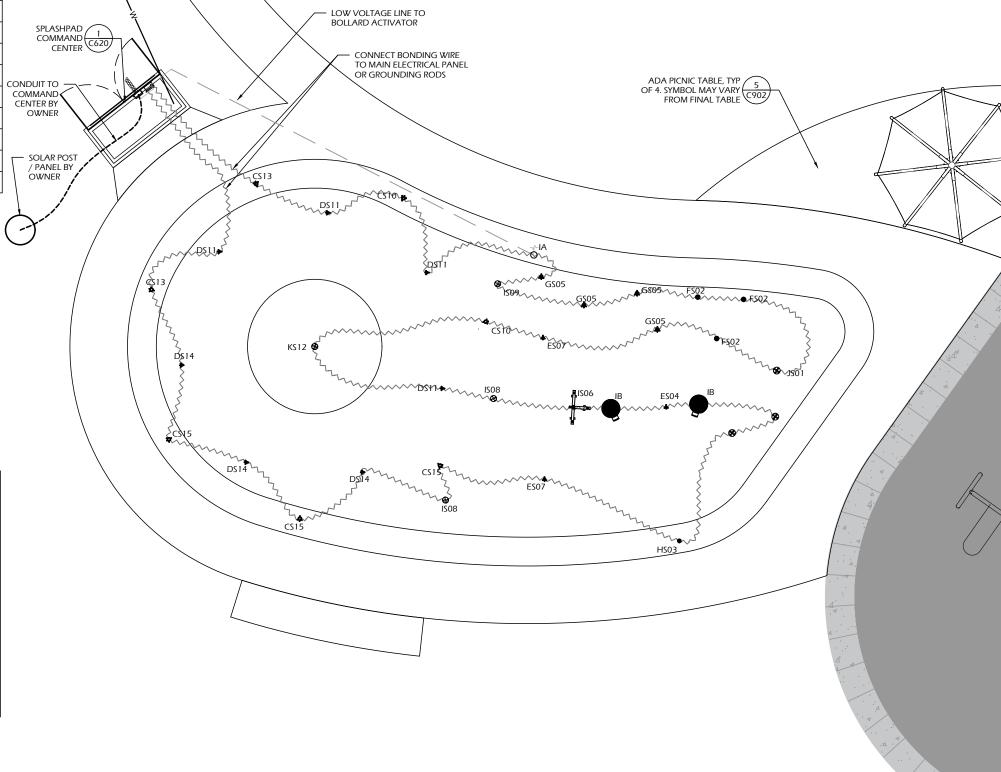



ELECTRICAL PLAN ٧ BONDING

RENNEBOHM PARK SPRAYGROUND 115 N. Eau Claire Avenue Madison, WI 53705

SPLASHPAD

24.017

Bidding 1/22/25

Project #: Issued For: Date:

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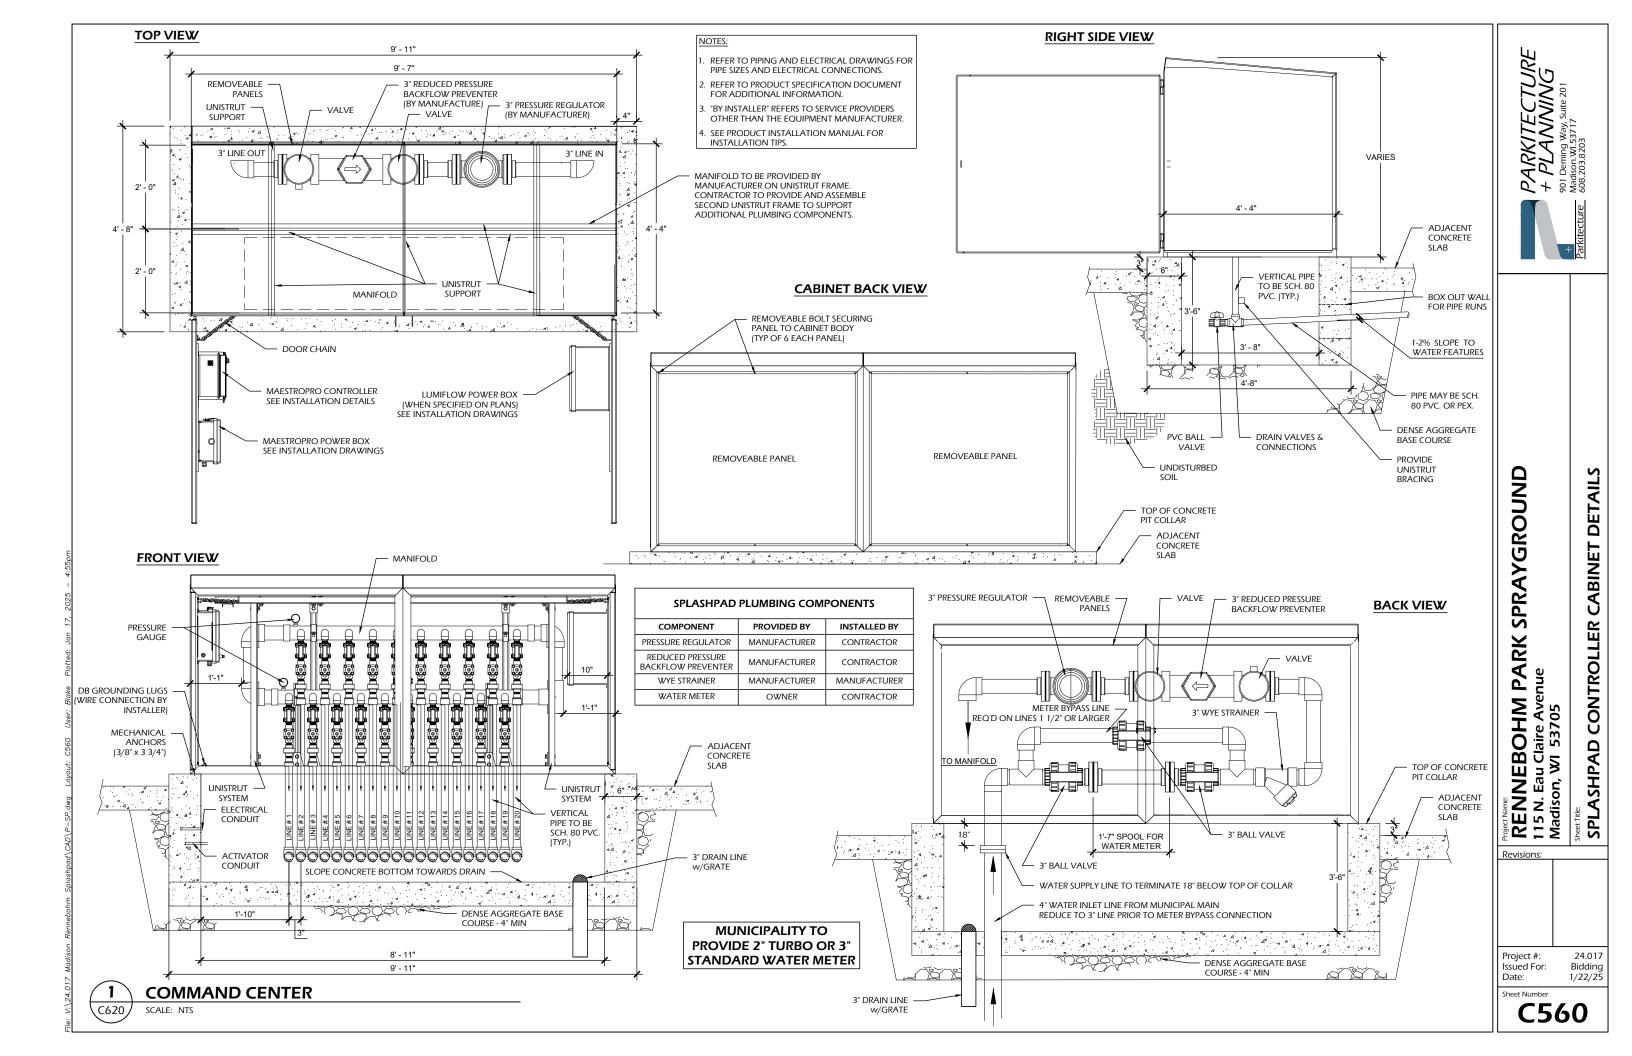
C540




RENNEBOHM PARK SPRAYGROUND 115 N. Eau Claire Avenue Madison, WI 53705

SPLASHPAD RENDERINGS

Project #: 24.0 Issued For: Biddi Date: 1/22/ Sheet Number 24.017 Bidding 1/22/25





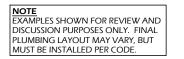



EXAMPLE MANIFOLD SIDE OF COMMAND CENTER (BY MANUFACTURER)








RENNEBOHM PARK SPRAYGROUND 115 N. Eau Claire Avenue Madison, WI 53705


SPLASHPAD CONTROLLER CABINET DETAILS


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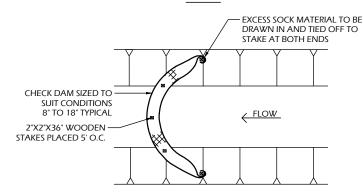
C561





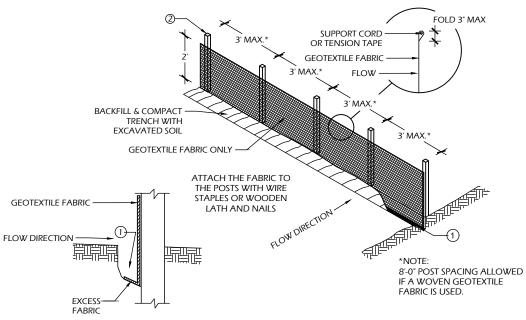

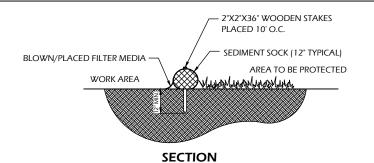PLAN

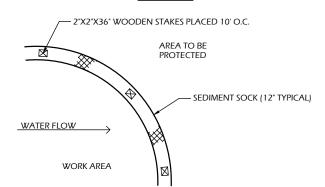

SEDIMENT SOCK NOTES:

1. ALL MATERIAL TO MEET SPECIFICATIONS.

- SEDIMENT SHOULD BE REMOVED FROM BEHIND CHECK DAM ONCE THE ACCUMULATED HEIGHT HAS REACHED ½ THE HEIGHT OF THE CHECK DAM.
- CHECK DAM CAN BE DIRECT SEEDED AT THE TIME OF INSTALLATION.
 FILTER MEDIA FILL TO MEET APPLICATION REQUIREMENTS.
- COMPOST MATERIAL TO BE DISPERSED ON SITE. AS DETERMINED BY ENGINEER.

SEDIMENT SOCK

SILT FENCE GENERAL NOTES


TRENCH DETAIL

FOR MANUAL INSTALLATIONS THE TRENCH SHALL BE A MINIMUM OF 4" WIDE & 6" DEEP TO BURY AND ANCHOR THE GEOTEXTILE FABRIC. FOLD MATERIAL TO FIT TRENCH AND BACKFILL & COMPACT TRENCH WITH EXCAVATED SOIL.


SILT FENCE

- 2. WOOD POSTS SHALL BE A MINIMUM SIZE OF 3' LENGTH OF OAK OR HICKORY
- 3. ADDITIONAL POST DEPTH OR TIE BACKS MAY BE REQUIRED IN UNSTABLE SOILS
- DETAILS OF CONSTRUCTION NOT SHOWN ON THIS DRAWING SHALL CONFORM TO THE PERTINENT REQUIREMENTS OF THE SPECIFICATIONS
- 5. 8" OF FENCE FABRIC REQUIRED BELOW GRADE IN TRENCH PER DNR TECH STD. 1056
- MANUFACTURED ALTERNATIVES APPROVED AND LISTED ON THE WISDOT PRODUCT ACCEPTABILITY LIST (PAL) MAY BE SUBSTITUTED.
- FINISHED SIZE, INCLUDING FLAP POCKETS WHERE REQUIRED, SHALL EXTEND A MINIMUM OF 10" AROUND THE PERIMETER TO FACILITATE MAINTENANCE OR REMOVAL
- 8. FLAP POCKETS SHALL BE LARGE ENOUGH TO ACCEPT WOOD 2"X4"


- 9. EROSION CONTROL SHALL BE PROVIDED IN ACCORDANCE WITH WDNR TECHNICAL STANDARD AND TECHNICAL SPECIFICATIONS.
- 10. CROSS BRACE WITH 2" X 4" WOODEN FRAME OR EQUIVALENT AT TOP OF POSTS AS DIRECTED
- 11. MINIMUM 14 GAUGE WIRE REQUIRED, FOLD FABRIC 3" OVER THE WIRE AND STAPLE OR PLACE WIRE RINGS ON 12" C.C.
- 12. WIRE SUPPORT FENCE SHALL BE 14 GAUGE MINIMUM WOVEN WIRE WITH A MAXIMUM MESH SPACING OF 6". SECURE TOP OF GEOTEXTILE FABRIC TO TOP OF FENCE WITH STAPLES OR
- 13. GEOTEXTILE FABRIC SHALL BE REINFORCED WITH AN INDUSTRIAL POLYPROPYLENE NETTING WITH A MAXIMUM MESH SPACING OF 3/4" OR EQUAL. A HEAVY DUTY NYLON TOP SUPPORT CORD OR EQUIVALENT IS REQUIRED. (TYPE A)
- 14. STEEL POSTS SHALL BE STUDDED "TEE" OR "U" TYPE WITH A MINIMUM WEIGHT OF 1.28 LBS./LIN. FT. IWITHOUT ANCHOR! FIN ANCHORS SUFFICIENT TO RESIST POST MOVEMENT ARE REQUIRED. WOOD POSTS SHALL BE A MINIMUM SIZE OF 1 1/8" X 1 1/8" OF OAK OR HICKORY.
- CONSTRUCT SILT FENCE FROM A CONTINUOUS ROLL, IF POSSIBLE, BY CUTTING LENGTHS TO AVOID JOINTS. IF A JOINT IS NECESSARY, USE ONE OF THE FOLLOWING TWO METHODS: A.J TWIST METHOD – OVERLAP THE END POSTS AND TWIST, OR ROTATE, AT LEAST 180 DEGREES, B:) HOOK METHOD - HOOK THE END OF EACH SILT FENCE LENGTH.

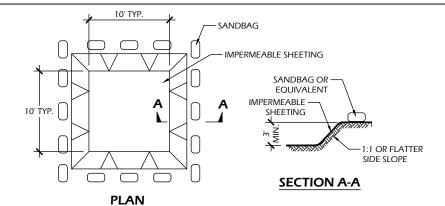

EXCAVATED WASHOUT STRUCTURE

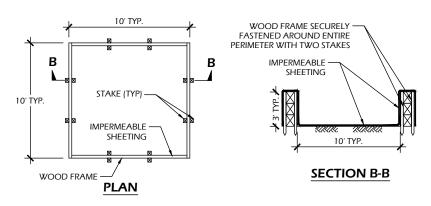

WASHOUT STRUCTURE WITH WOOD PLANKS

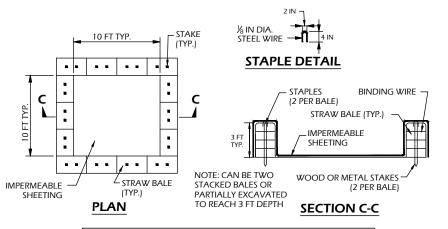

WASHOUT STRUCTURE WITH STRAW BALES

CONSTRUCTION SPECIFICATIONS

- TEMPORARY CONCRETE WASHOUT STRUCTURE SHALL BE USED TO WASH DOWN CONCRETE TRUCK CHUTES AND OTHER EQUIPMENT AFTER USE TO PREVENT WASHDOWN WATER FROM POLLUTING THE SITE.
- 2. LOCATE WASHOUT STRUCTURE A MINIMUM OF 50 FEET AWAY FROM OPEN CHANNELS, STORM DRAIN INLETS, SENSITIVE AREAS, WETLANDS, BUFFERS AND WATER COURSES AND AWAY FROM CONSTRUCTION
- 3. SIZE WASHOUT STRUCTURE FOR VOLUME NECESSARY TO CONTAIN WASH WATER AND SOLIDS AND MAINTAIN AT LEAST 4 INCHES OF FREEBOARD. TYPICAL DIMENSIONS ARE 10 FEET X 10 FEET X 3 FEET DEEP.
- 4. PREPARE SOIL BASE FREE OF ROCKS OR OTHER DEBRIS THAT MAY CAUSE TEARS OR HOLES IN THE LINER. FOR LINER, USE 10 MIL OR THICKER UV RESISTANT, IMPERMEABLE SHEETING, FREE OF HOLES AND TEARS OR OTHER DEFECTS THAT COMPROMISE IMPERMEABILITY OF THE MATERIAL.
- 5. PROVIDE A SIGN FOR THE WASHOUT IN CLOSE PROXIMITY TO THE FACILITY
- KEEP CONCRETE WASHOUT STRUCTURE WATER TIGHT. REPLACE IMPERMEABLE LINER IF DAMAGED (E.G., RIPPED OR PUNCTURED). EMPTY OR REPLACE WASHOUT STRUCTURE THAT IS 75 PERCENT FULL, AND DISPOSE OF ACCUMULATED MATERIAL PROPERLY. DO NOT REUSE PLASTIC LINER. WET-VACUUM STORED LIQUIDS THAT HAVE NOT EVAPORATED AND DISPOSE OF IN AN APPROVED MANNER. PRIOR TO FORECASTED RAINSTORMS, REMOVE LIQUIDS OR COVER STRUCTURE TO PREVENT OVERFLOWS. REMOVE HARDENED SOLIDS, WHOLE OR BROKEN UP, FOR DISPOSAL OR RECYCLING. MAINTAIN RUNOFF DIVERSION AROUND EXCAVATED WASHOUT STRUCTURE UNTIL STRUCTURE IS REMOVED.



CONCRETE WASHOUT STRUCTURE (TEMP)

SCALE: NTS

SPRAYGROUN


RENNEBOHM PARK 115 N. Eau Claire Avenue


DETAIL

CONSTRUCTION

Project #: Issued For: Bidding 1/22/25 Date:

Sheet Number C900

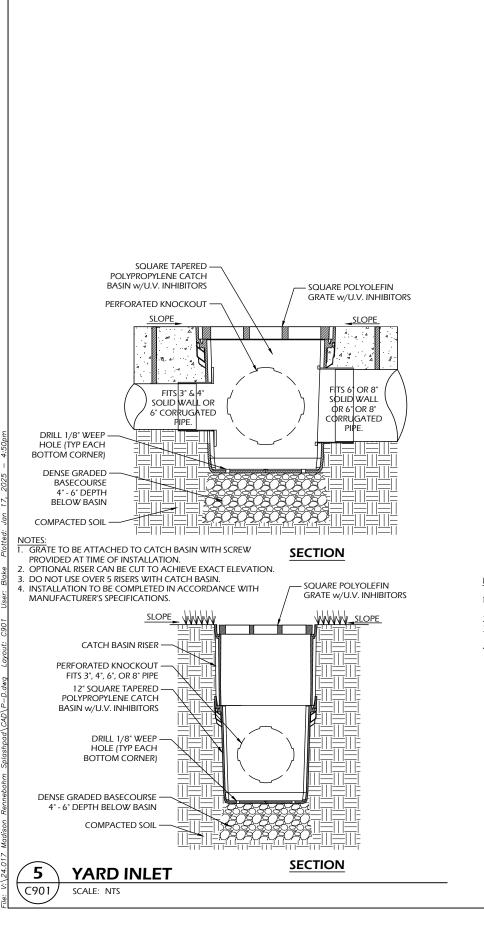

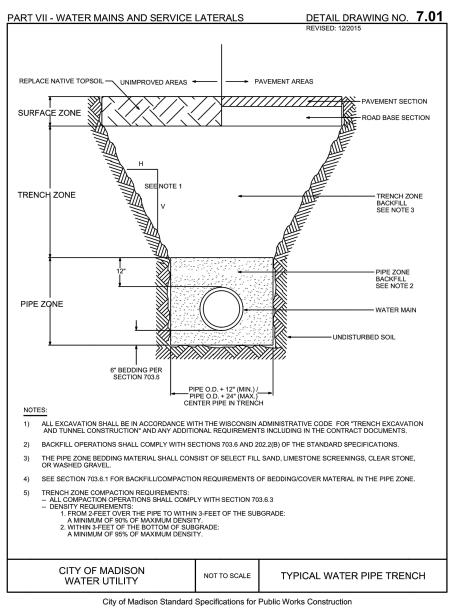



UTILITY TRENCH SECTION SCALE: NTS

C901 **NOTES**

C901

SCALE: NTS

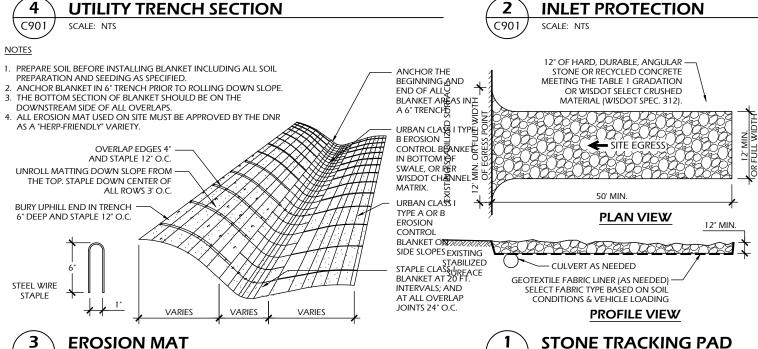

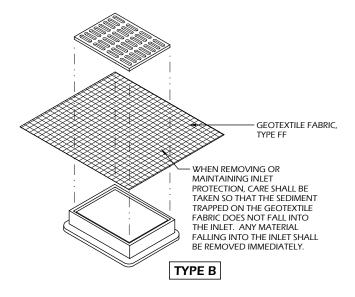

INLET PROTECTION NOTES:

- 1. INSTALL PER WDNR STORM WATER CONSTRUCTION TECHNICAL STANDARD 1060.
- 2. INLET PROTECTION TYPE B SHALL BE USED ON STRUCTURES 30" OR LESS IN DEPTH.
- 3. ROUTINELY INSPECT FOR INTEGRITY AND NEEDED MAINTENANCE. 4. EMPTY SEDIMENT WHEN THE BAG IS HALF FULL OR SEDIMENT IS WITHIN 6 INCHES OF THE OVERFLOW HOLES, OR AS DIRECTED BY
- THE OWNER OR A/E.

 5. IMMEDIATELY REMOVE ANY SEDIMENT FALLING INTO THE INLET DURING MAINTENANCE ACTIVITIES.
- 6. INLET PROTECTION SHALL BE REMOVED AFTER THE SITE HAS ACHIEVED 80% STABILIZATION OR AT THE END OF THE PROJECT.

RIGID FRAME INLET PROTECTION REPLACEABLE

FILTER BAG

CURB BACK -

EXTENSION

GALVANIZED STEEL

WOVEN OUTER

C901

SCALE: NTS

BAG LAYER

NON-WOVEN INNER **BAG LINER**

(COVERING LOWER

HALF OF BAG)

FRAMING

TABLE 1				
AGGRE	GATE GRADATION			
SIEVE	PERCENT PASSING			
SIZE	BY WEIGHT			
3"	100			
2 1/2"	90 - 100			
1 1/2"	25 - 60			
3/4"	0 - 20			
3/8"	0 - 5			

OPERATION & MAINTENANCE:

- 1. MONITOR TRACKING PADS FOR COMPACTION, SOIL DEPOSITS, AND MIXING OF UNDERLYING SOILS AND STONE LAYERS.
- 2. MAINTAIN A LOOSENED, ROUGH SURFACE BY SCRAPING, LOOSENING, OR TOP-DRESSING WITH ADDITIONAL AGGREGATE.
- 3. REPLACE GEOTEXTILE AND STONE IF LESS-INTENSIVE MAINTENANCE EFFORTS FAIL TO REESTABLISH EFFECTIVENESS.
- 4. ADD STONE AS NEEDED TO MAINTAIN THE MINIMUM PAD THICKNESS.
- 5. REPLACE DAMAGED OR CRUSHED CULVERTS UNDER TRACKING PAD.

24.017 Project #: Issued For: Bidding 1/22/25 Date:


SPRAYGROUN

RENNEBOHM PARK 115 N. Eau Claire Avenue Madison, WI 53705


DETAIL


CONSTRUCTION

Sheet Number C901

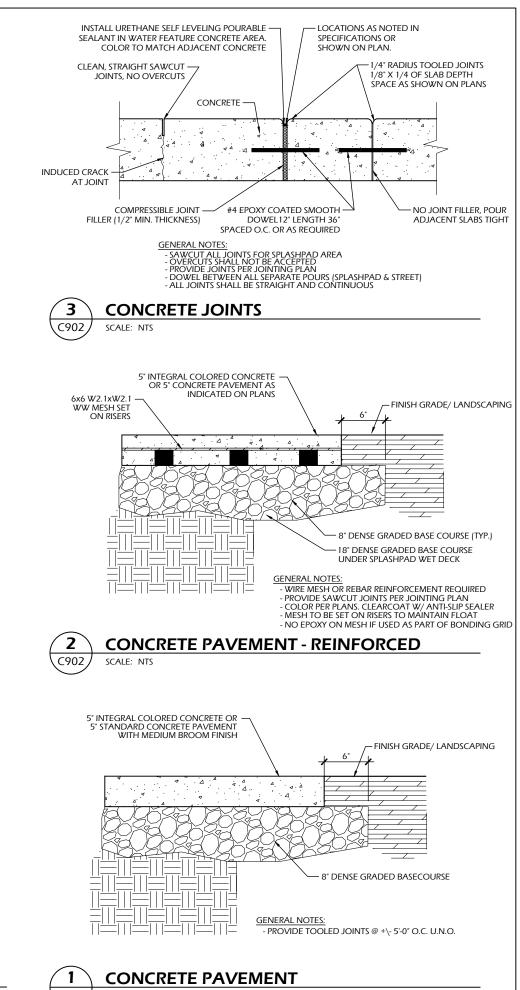

Round Coated Steel Pedestal Tables

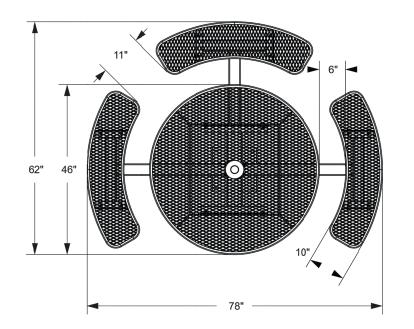

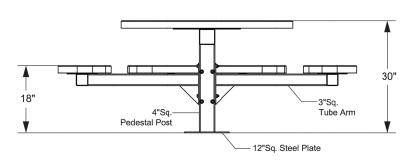

PICNIC TABLE C902 SCALE: NTS

NOTES:

1.5" LETTER HEIGHT -

1" MINIMUM LETTER HEIGHT

1. SIGN SHALL BE AN ALUMINUM BOARD WITH SHEET VINYL.

13. REPORT CONCERNS TO PARK STAFF AT xxx-xxx-xxxx. SPLASHPAD IS OPEN TO THE PUBLIC **RESERVATIONS WILL NOT BE ACCEPTED** 2'-6"

2. MOUNT TO CONTROLLER CABINET WITH TAMPERPROOF FASTENERS.

RENNEBOHM PARK SPRAYGROUND RULES 115 N. EAU CLAIRE AVE

4. REMEMBER TO BE RESPECTFUL AND SHARE WITH OTHERS AT

5. ALL CHILDREN 8 AND YOUNGER SHOULD BE ACCOMPANIED BY

10. CHILDREN MUST BE TOILET TRAINED OR WEAR SWIM DIAPERS. 11. DIAPER CHANGING IS PERMITTED IN DESIGNATED AREAS ONLY, AND NOT ALLOWED ON SPLASH AREA. 12. BE MINDFUL OF THE WEATHER. THIS SPLASHPAD WILL BE

7. DO NOT BRING FOOD, DRINK, GUM, TOBACCO, GLASS, OR

8. DO NOT BRING ANIMALS INTO THE SPLASHPAD AREA.

3'-0"

HOURS OF OPERATION:

ALL TIMES.

AN ADULT.

IN CASE OF EMERGENCY, DIAL 911.

2. THIS SPLASHPAD IS UNSUPERVISED AT ALL TIMES. 3. NO RUNNING OR ROUGH PLAY. HAVE FUN!

6. DO NOT ENTER THE SPLASHPAD IF YOU HAVE A COMMUNICABLE DISEASE OR AN OPEN CUT.

STREET SHOES INTO THE SPLASHPAD.

9. RECREATIONAL WHEEL-BASED METHODS OF

SERVICE ANIMALS ARE ALLOWED.

TRANSPORTATION ARE PROHIBITED.

CLOSED DURING SEVERE WEATHER.

- 3. SIGN SHALL BE LEVEL.
- 4. FINAL LOCATIONS TO BE APPROVED BY OWNER.
- 5. COLORS SHALL BE DETERMINED BY OWNER AND A/E DURING SUBMITTALS.



SPLASHPAD RULES SIGN

SCALE: NTS

C902 SCALE: NTS Sheet Number **C902**

SPRAYGROUN

RENNEBOHM PARK 115 N. Eau Claire Avenue Madison, WI 53705

Project #:

Issued For: Date:

DETAILS

CONSTRUCTION

24.017

Bidding 1/22/25

C903 SCALE: NTS

SPLASHPAD TYP. SECTION

SPLASHPAD NOTES

CROWN DRIP LINE OR OTHER LIMIT OF

TREE PROTECTION ZONE (TPZ).

- SPLASHPAD DECK SHALL NOT EXCEED 5% RUNNING OR 2% CROSS SLOPES UNLESS OTHERWISE INDICATED, AND MAINTAIN A 1% MINIMUM SLOPE ON ALL WET DECK AREAS.
- . THE SPLASHPAD WET DECK SHALL SLOPE TOWARD DRAINS WITHOUT CREATING AREAS OF POOLING WATER. AREAS HOLDING STANDING WATER MORE THAN 1/8" DEEP (THICKNESS OF A QUARTER) 15 MINUTES AFTER SPRAY FEATURES ARE TURNED OFF ARE CONSIDERED TO FAIL THE SLOPE REQUIREMENTS.

Notes: 1- SEE SPECIFICATIONS FOR ADDITIONAL

- . CONTRACTOR TO ADJUST SPRAY FEATURE ELEVATIONS IN THE FIELD AS NEEDED.
- 4. FEATURES SHOWN MAY VARY. INSTALL PER MANUFACTURER'S STANDARD DETAILS.

NEENAH CASTINGS R-2500, W/TYPE "H" OPEN GRATE CONCRETE ADJUSTING RINGS, 2" OR 4" THICKNESS AS REQUIRED 4" MIN WALL 24" HOLE DEPTH AS SHOWN ON PLANS MORTAR SEALS PREFORMED **PLAN VIEW** CONCRETE BASE -6" MINIMUM OF ¾" WASHED **PROFILE VIEW**

STORM INLET

SCALE: NTS

C903

SEE PLANS OR A/E DIRECTION FOR TREE PROTECTION REQUIREMENTS. FENCE ALIGNMENTS. 2- IF THERE IS NO IRRIGATION, SEE SPECIFICATIONS FOR WATERING REQUIREMENTS. 3- NO PRUNING SHALL BE PERFORMED EXCEPT BY APPROVED CERTIFIED ARBORIST. 4- NO EQUIPMENT SHALL OPERATE OR MATERIALS BE STORED INSIDE FENCING INCLUDING DURING FENCE INSTALLATION AND REMOVAL. 5- SEE LANDSCAPE PLANS FOR ANY MODIFICATIONS WITH THE TPZ. TREE PROTECTION FENCE SHALL BE HIGH DENSITY POLYETHYLENE WITH 3.5"X1.5" OPENINGS. COLOR - ORANGE STEEL POSTS INSTALLED AT 8' OC MAX. 8.5" x 11 LAMINATED SIGN - 2" x 6' STEEL POSTS OR APPROVED SPACED EVERY EQUAL. 50' ALONG FENCE. MAINTAIN EX. GRADE WITH THE TREE KEEP OUT TREE PROTECTION FENCE UNLESS OTHERWISE INDICATED ON THE PROTECTION AREA

TREE PROTECTION C903

SCALE: NTS

RENNEBOHM PARK SPRAYGROUND 115 N. Eau Claire Avenue Madison, WI 53705 CONSTRUCTION

DETAILS


Project #: Issued For: Date:

Sheet Number

C903

24.017

Bidding 1/22/25

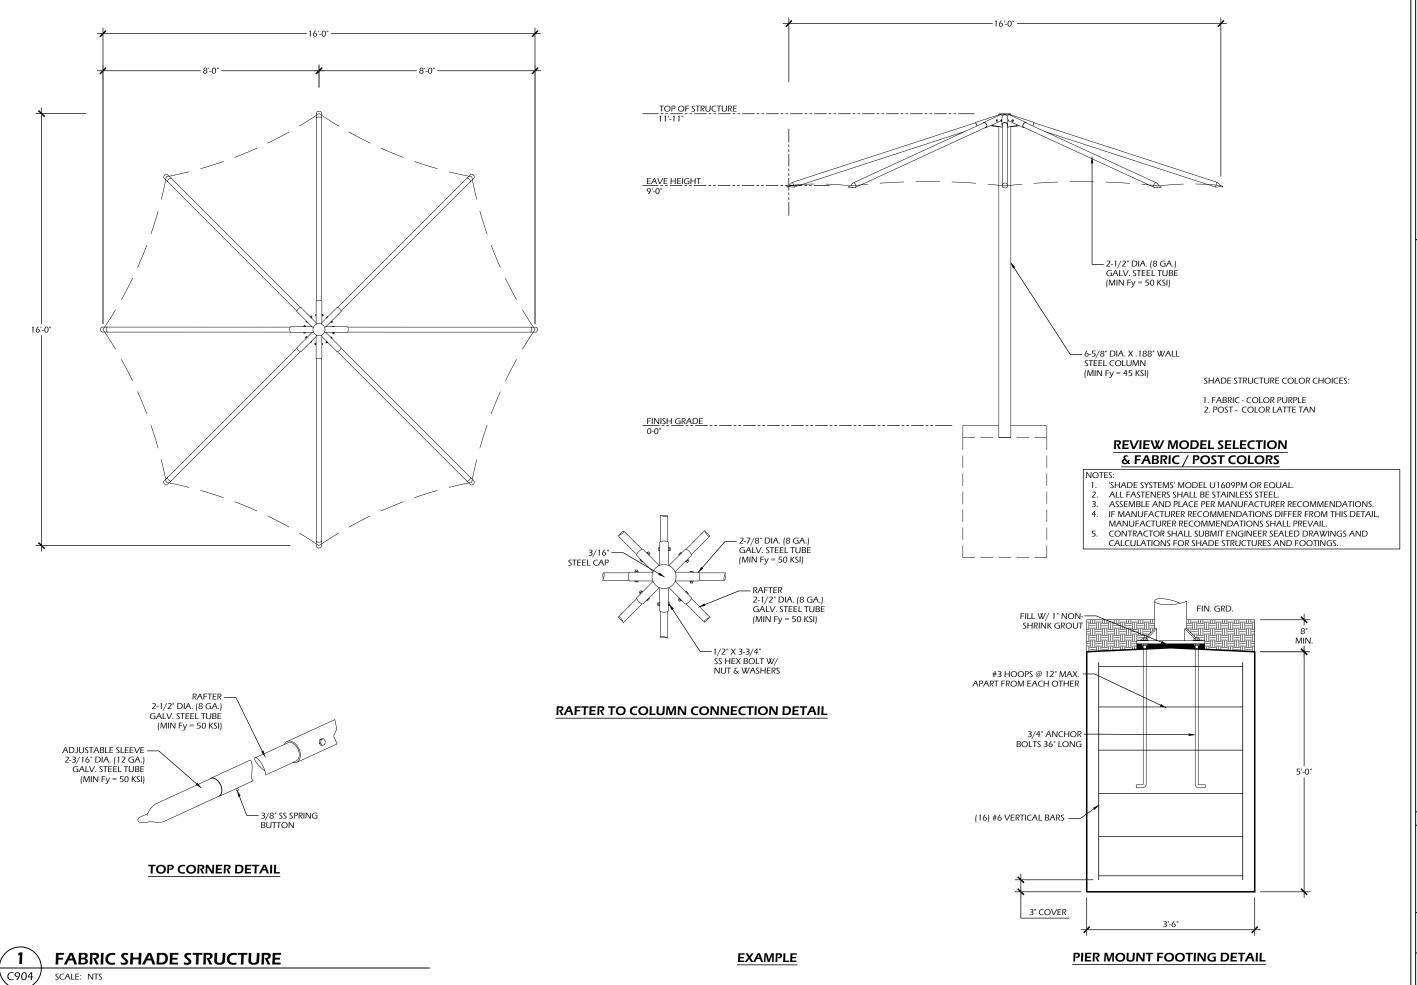


RENNEBOHM PARK SPRAYGROUND 115 N. Eau Claire Avenue Madison, WI 53705


CONSTRUCTION DETAILS 24.017 Bidding 1/22/25


Project #: Issued For: Date:

Sheet Number

C904

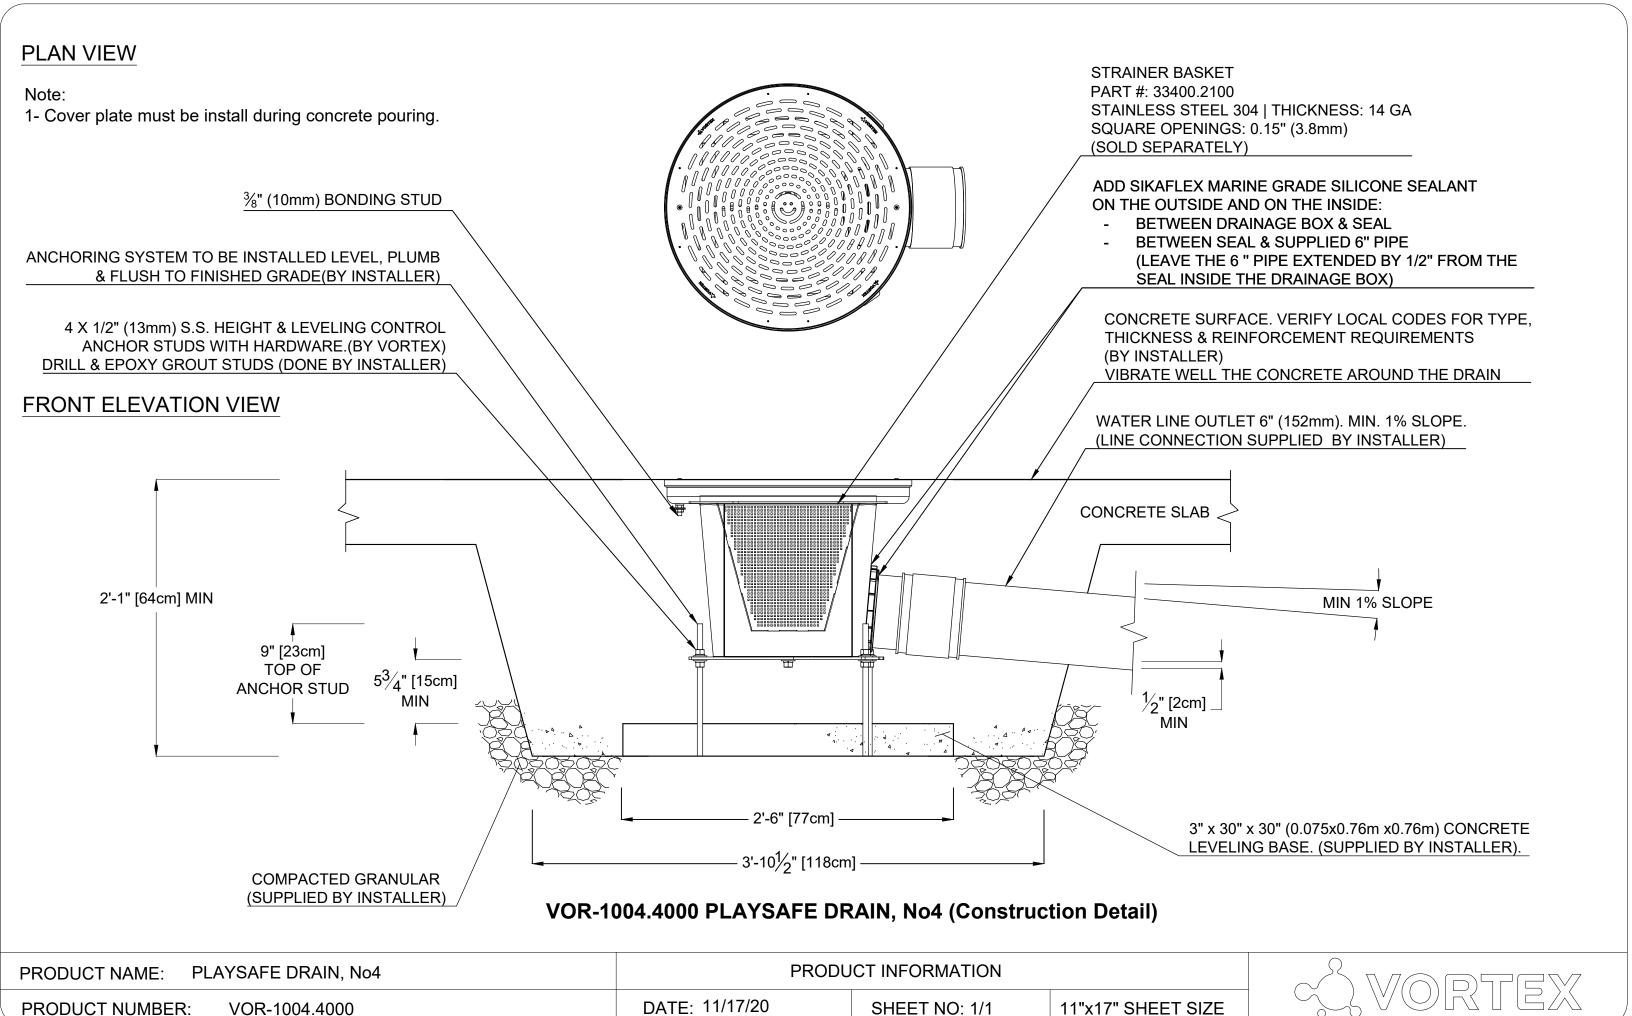

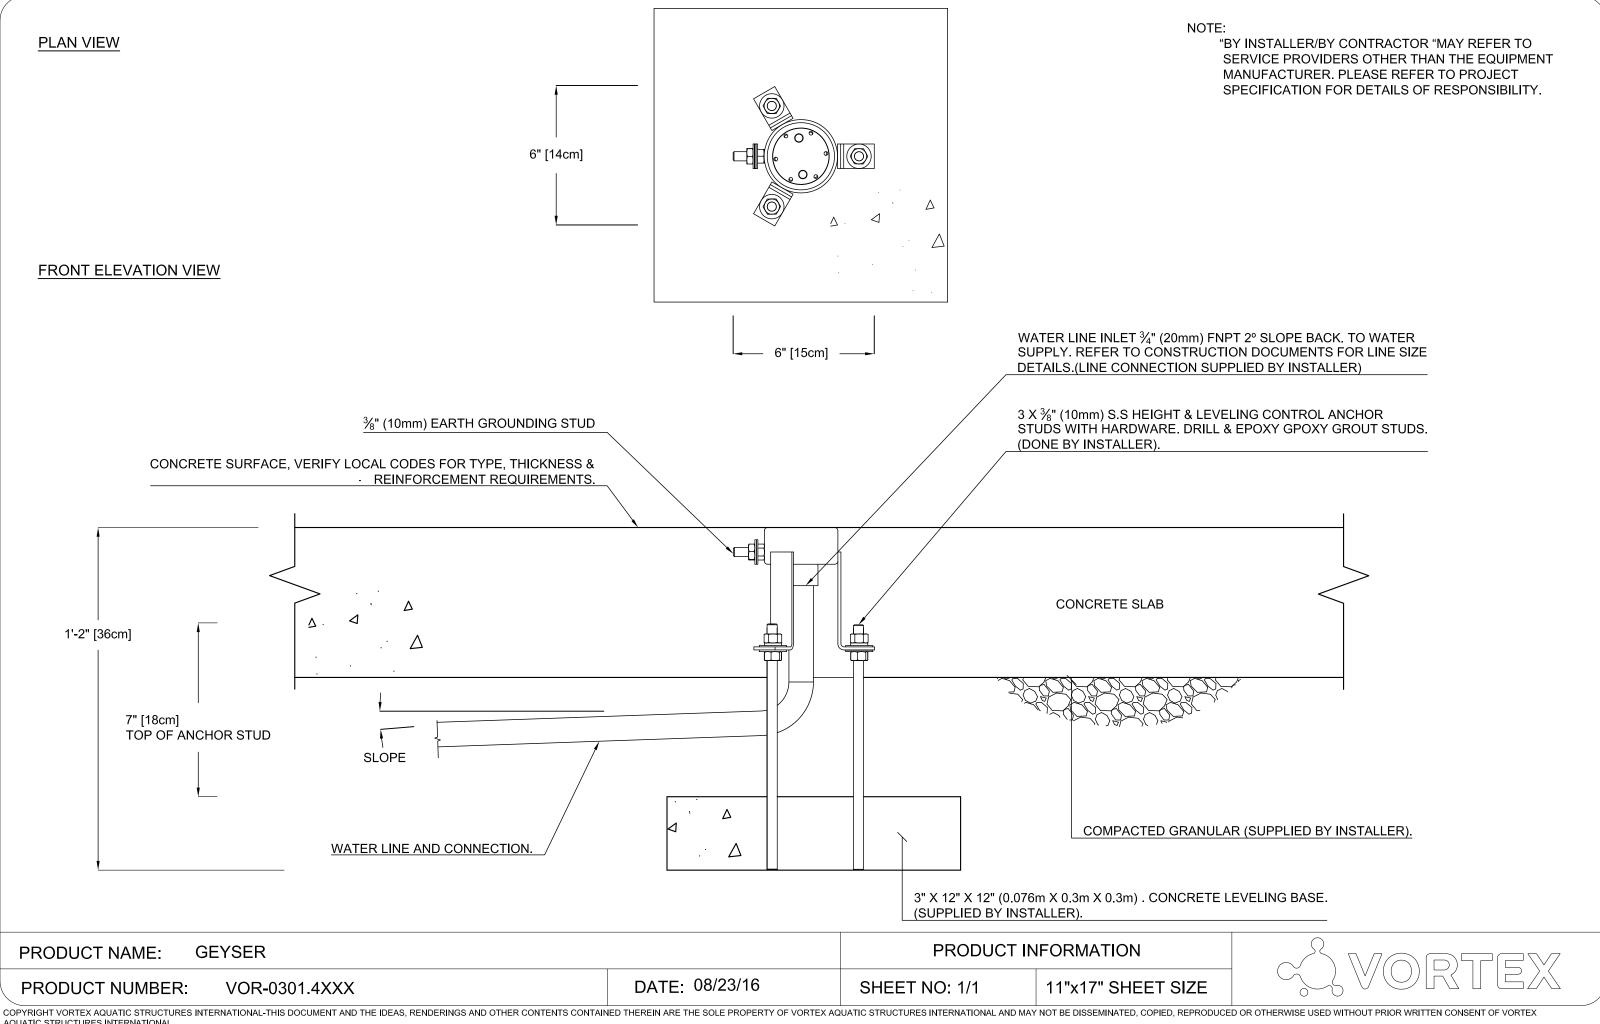


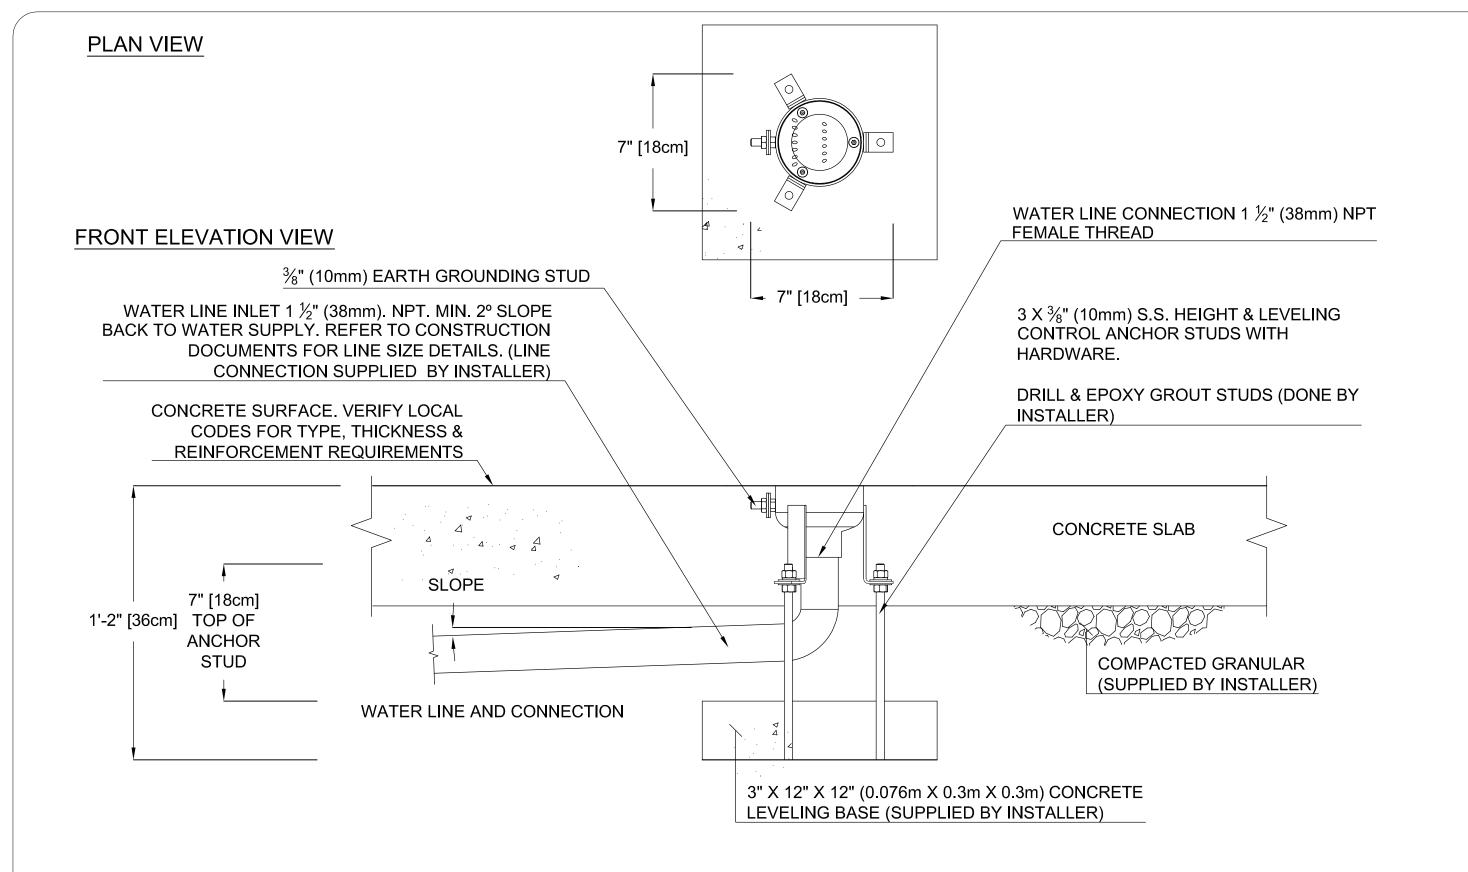


VOR-0303.4XXX ROOSTER TAIL (Construction Detail)


PRODUCT NAME: ROOSTER TAIL	PRODUCT INFORMATION			
PRODUCT NUMBER: VOR-0303.4XXX	DATE: 04/17/12	SHEET NO: 1/1	11"x17" SHEET SIZE	



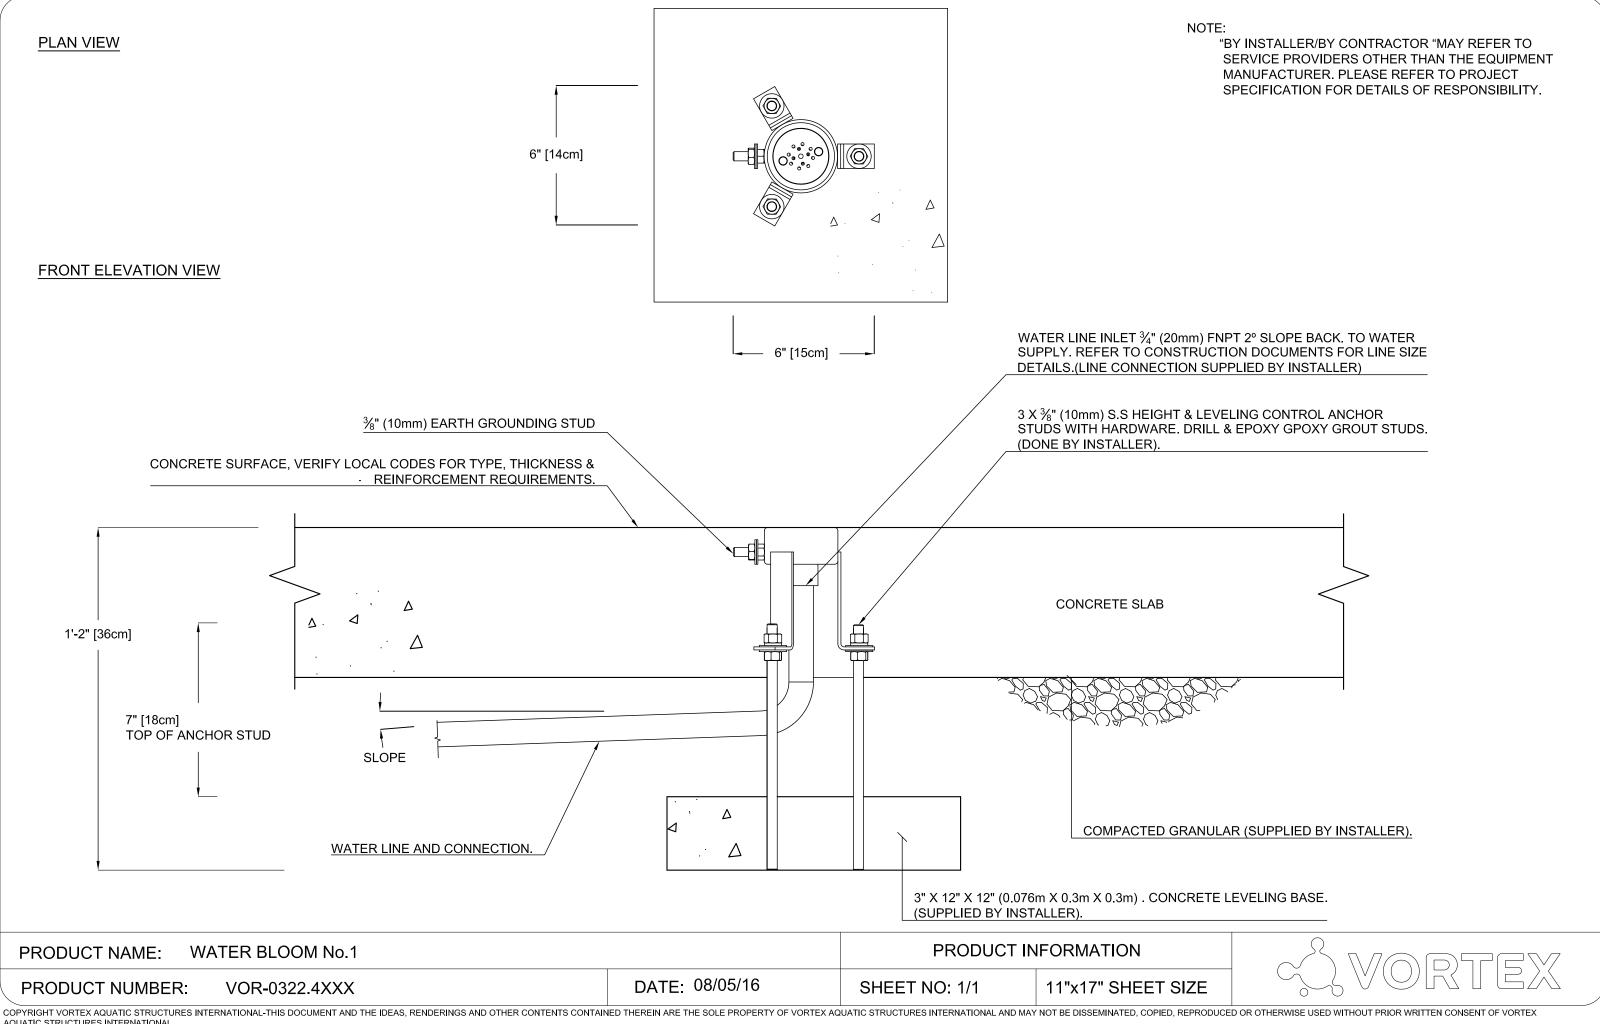

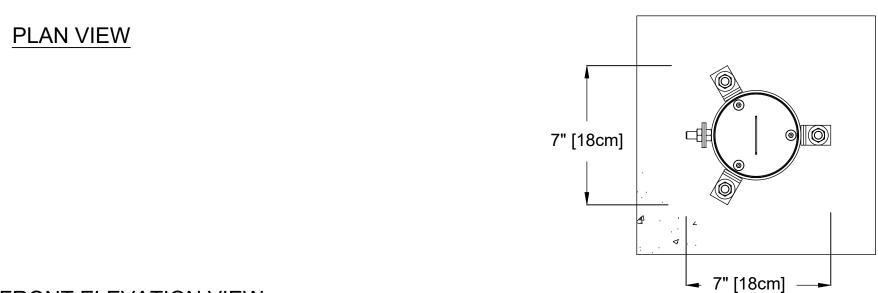


FRONT ELEVATION VIEW

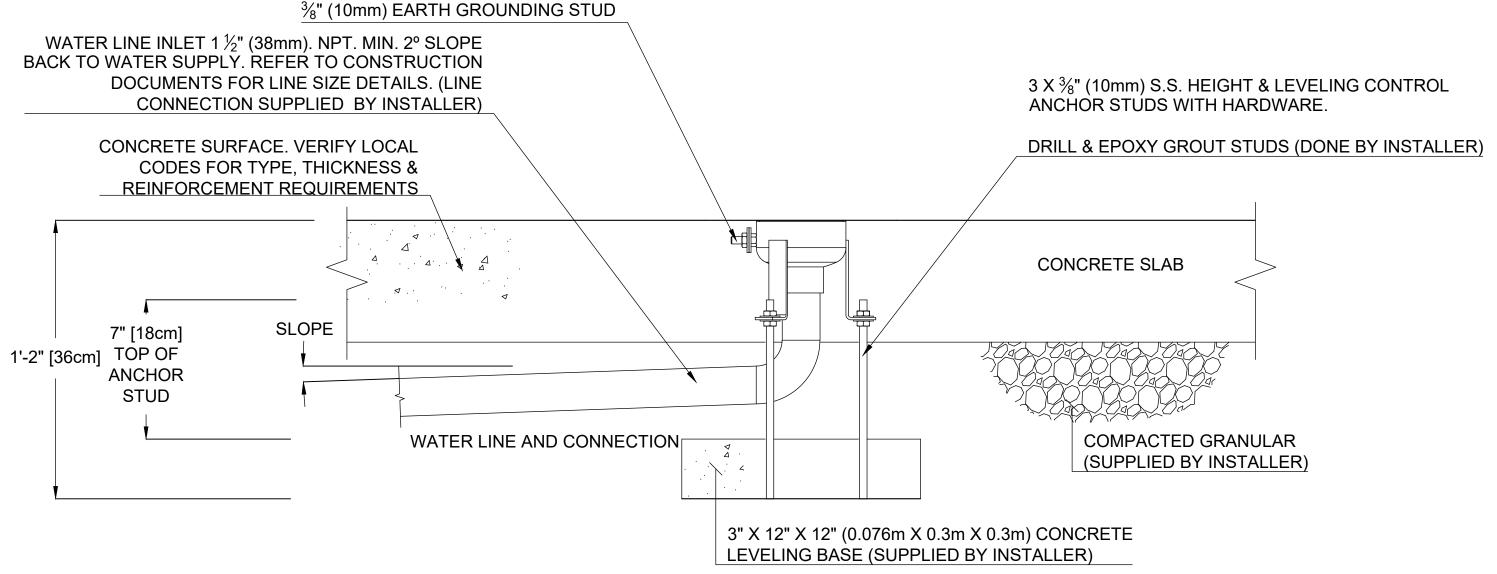


VOR-0325.4XXX JET STREAM No.2 (Construction Detail)

PRODUCT NAME: JET STREAM No.2	PRODUCT INFORMATION			
PRODUCT NUMBER: VOR-0325.4XXX	DATE: 08/22/24	SHEET NO: 1/1	11"x17" SHEET SIZE	




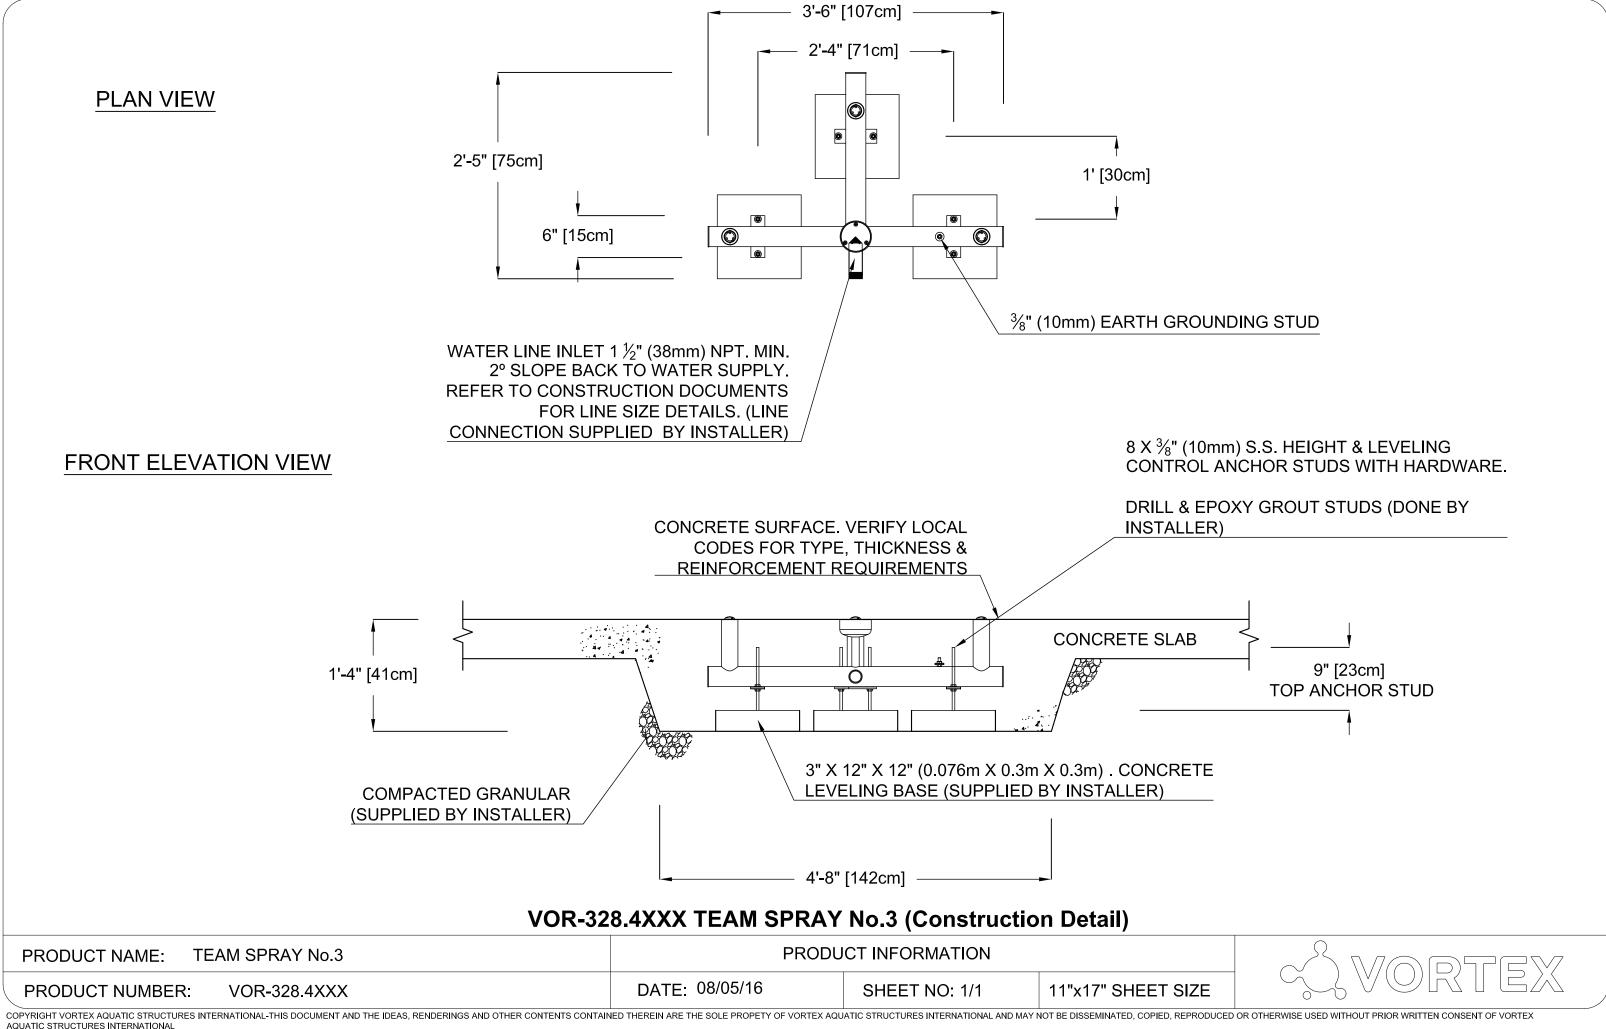


PLAN VIEW

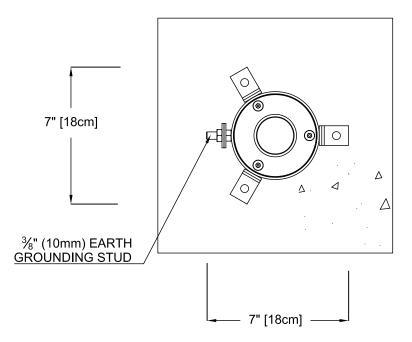

FRONT ELEVATION VIEW

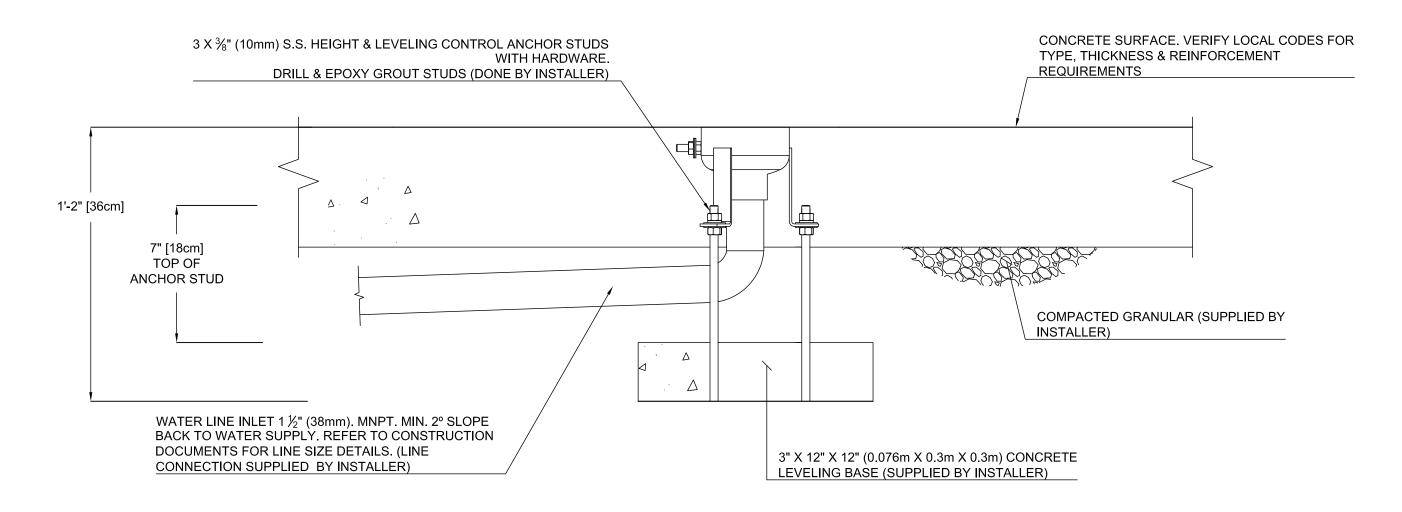


PRODUCT NAME: WATER JELLY N°1		PRODUCT IN	IFORMATION
PRODUCT NUMBER: VOR-7010.0002	DATE: 03/20/18	SHEET NO: 1/1	11"x17" SHEET SIZE

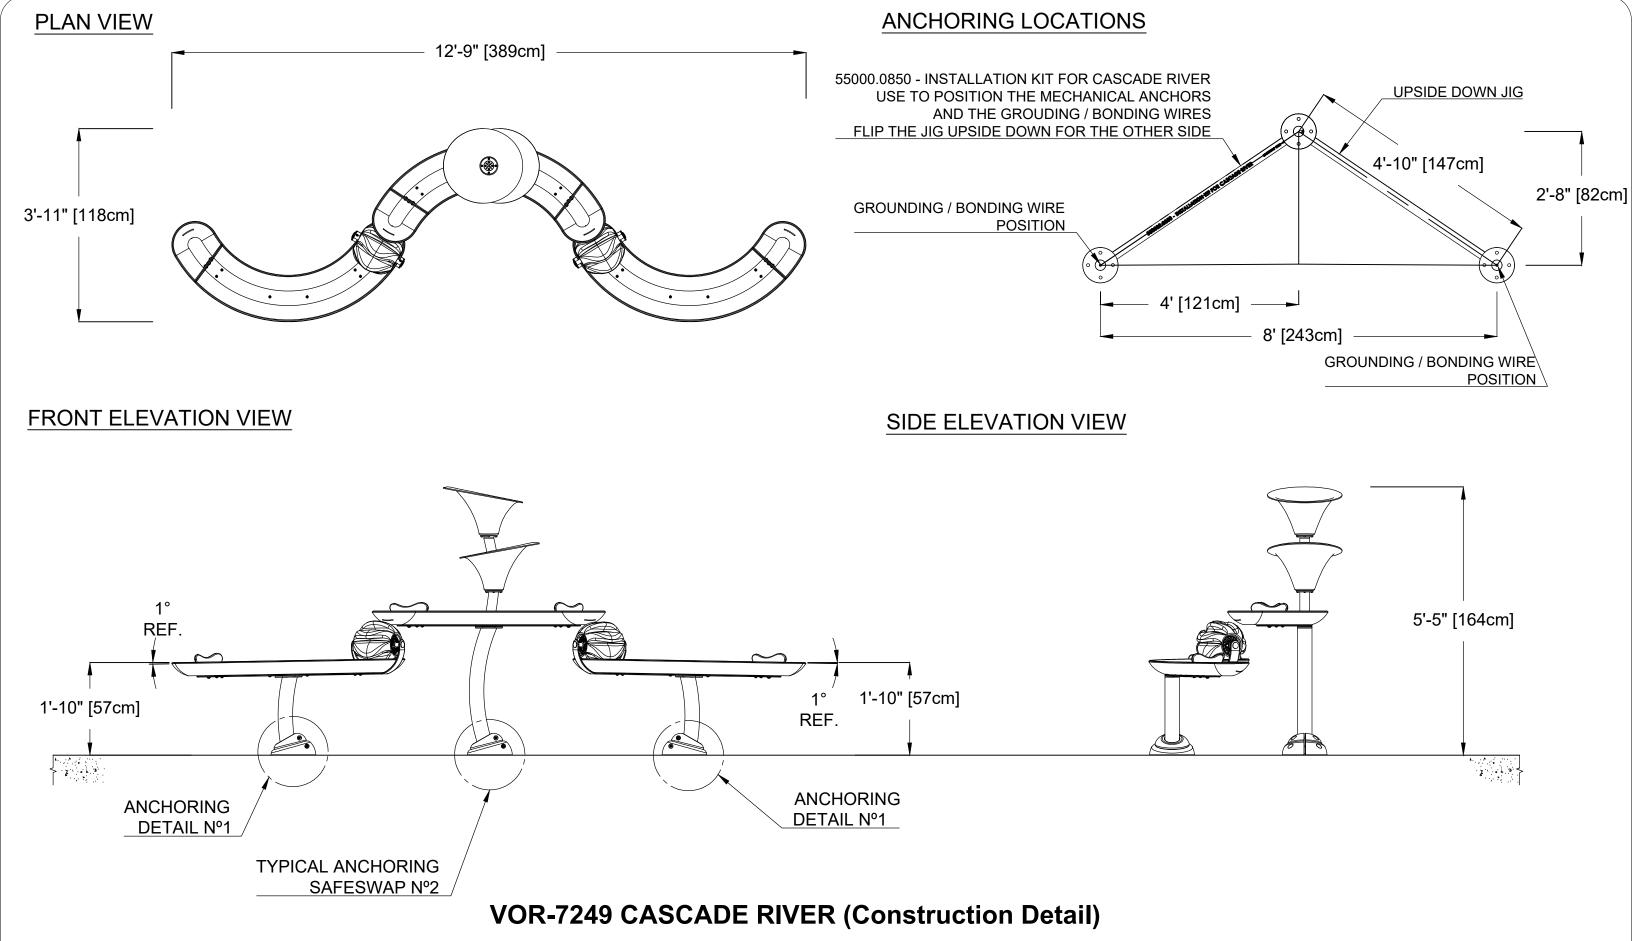


PRODUCT NAME: CASCADE RIVER

PRODUCT NUMBER: VOR-7249

DATE: 04/30/21 SHEET NO: 1/2 11"x17" SHEET SIZE

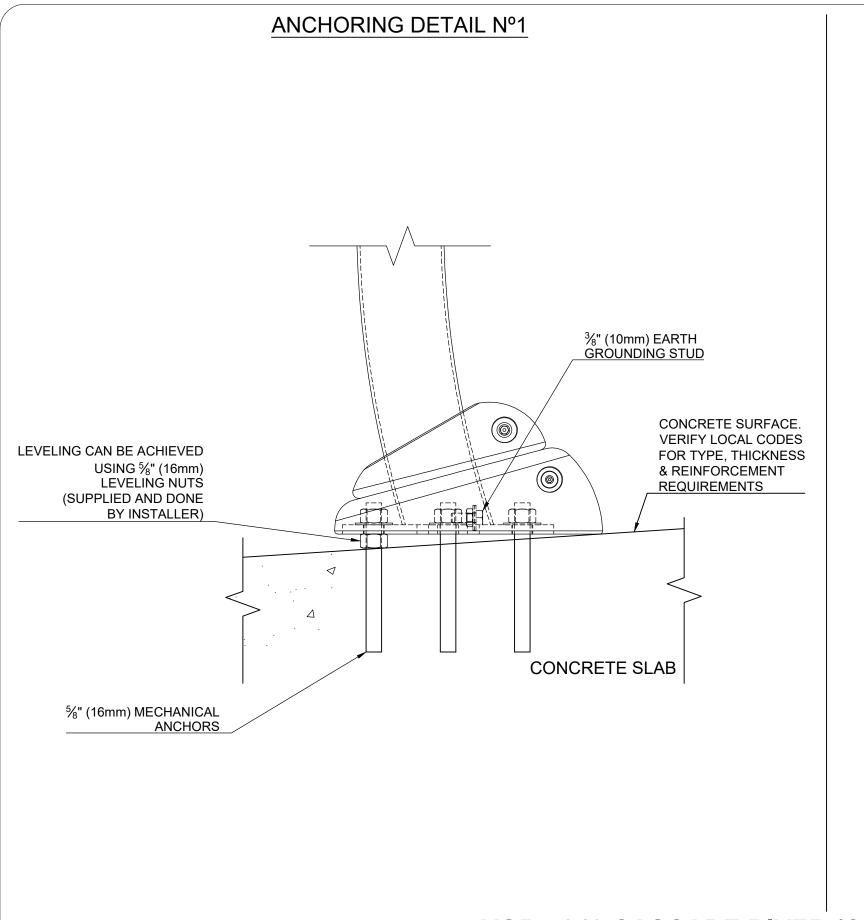

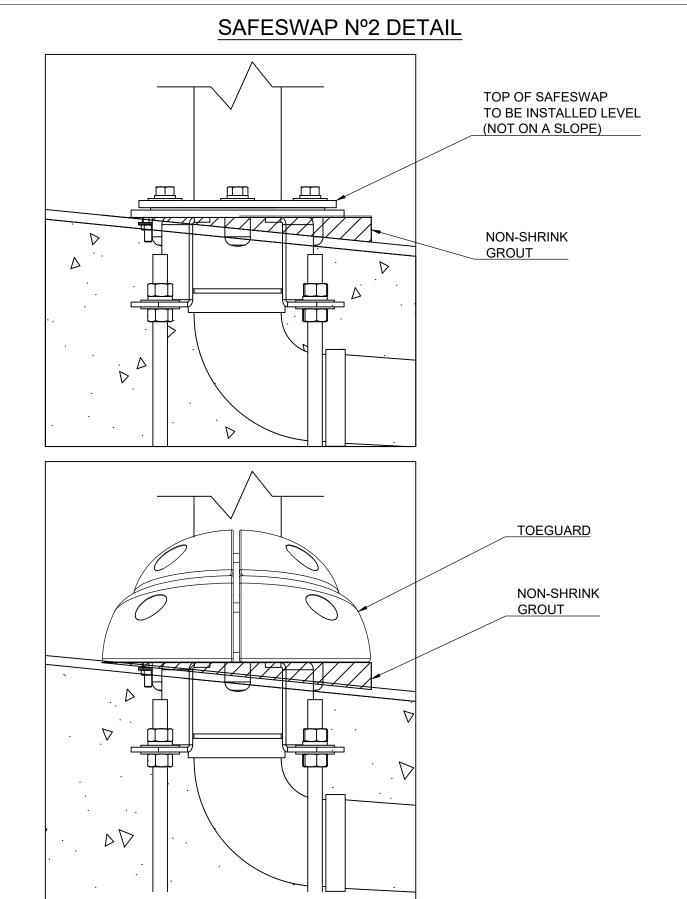

VOR-7249 CASCADE RIVER (Construction Detail)


PRODUCT NAME: CASCADE RIVER

PRODUCT NUMBER: VOR-7249

DATE: 03/07/21 SHEET NO: 2/2 11"x17" SHEET SIZE





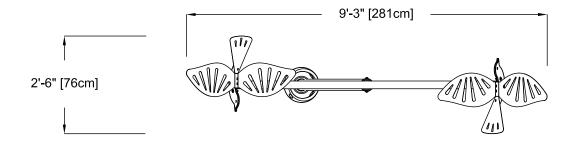

FRONT ELEVATION VIEW

SIDE ELEVATION VIEW

ASSEMBLY INSTRUCTIONS:


1- WHILE THE PRODUCT IS IN A HORIZONTAL POSITION, REMOVE THE SCREWS AND WASHERS FROM THE BOTTOM CASING OF THE TOP SUBASSEMBLY.

- 2- REMOVE TAPE OVER END OF CASING OF THE TOP SUBASSEMBLY. ENSURE BEARING IN THE END OF CASING DOES NOT FALL OUT.
- 3- SLIDE THE CASING OF THE TOP SUBASSEMBLY INTO THE CASING OF THE BOTTOM SUBASSEMBLY AND OVER THE SHAFT
 ENSURE BEARING IN TOP SUBASSEMBLY DOES NOT FALL
- ENSURE BEARING IN TOP SUBASSEMBLY DOES NOT FALL OUT.
- 4- ALIGN HOLES OF CASING FROM THE BOTTOM SUBASSEMBL

WITH THE HOLES OF THE CASING IN THE TOP SUBASSEMBLY.

RE-INSTALL WASHERS AND SCREWS PREVIOUSLY REMOVE FROM TOP SUBASSEMBLY.

5- INSTALL FEATURE ONTO ANCHOR.

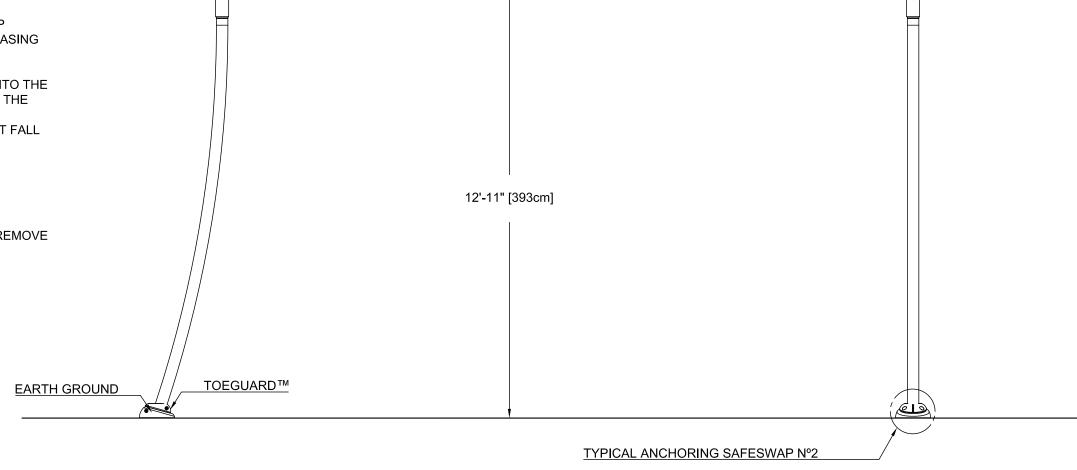

PRODUCT NAME: HELICO BIRDS


PRODUCT NUMBER: VOR-7258.2XXX

DATE: 01/04/24

SHEET NO: 1/1

11"x17" SHEET SIZE



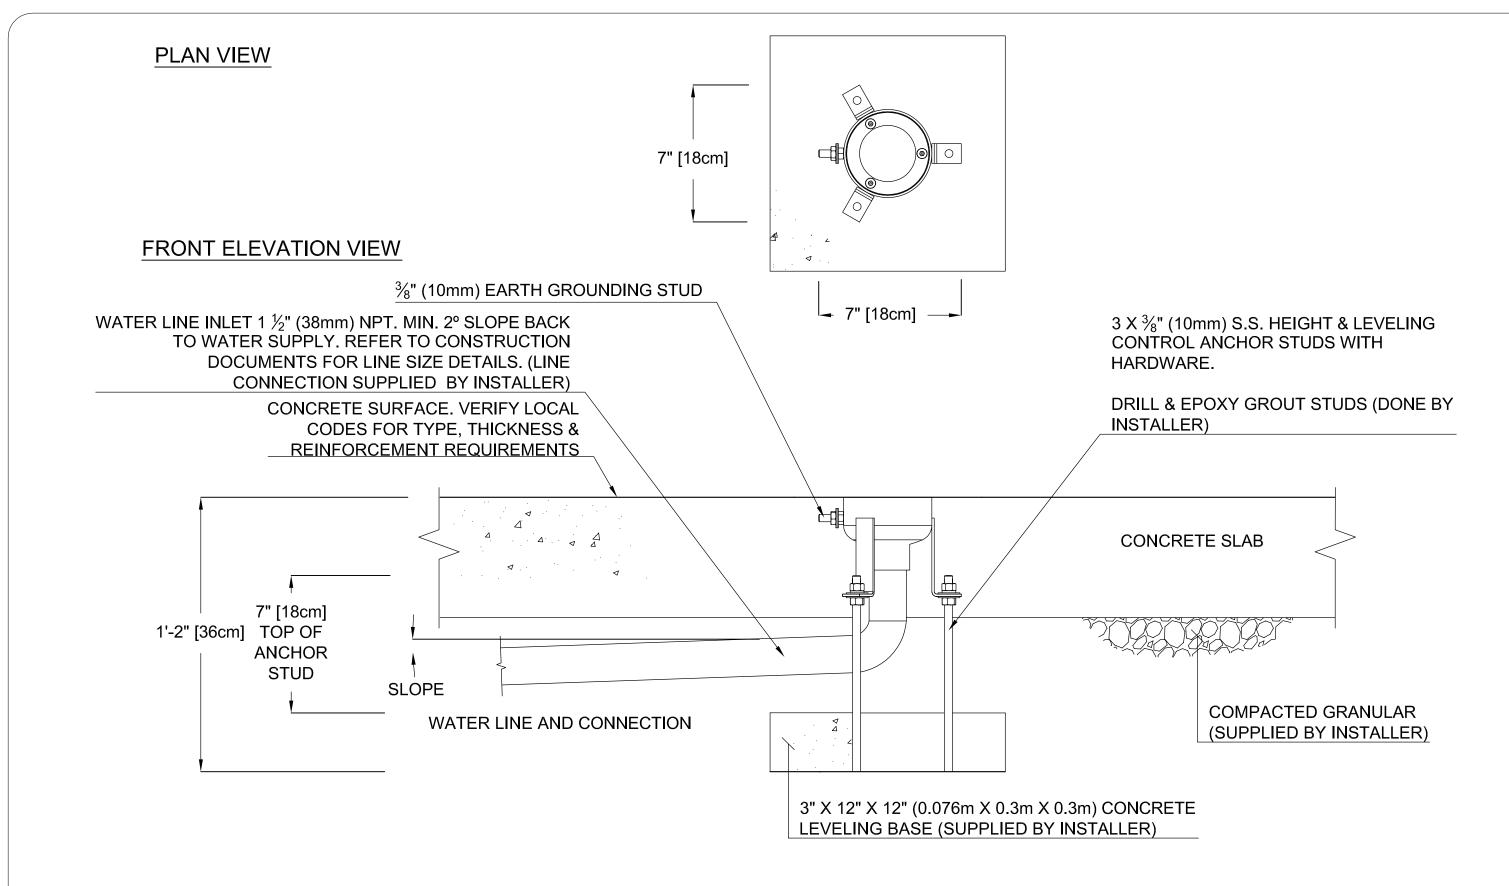


VOR-7516.0XXX SPLIT STREAM (Construction Detail)

PRODUCT NAME: SPLIT STREAM	PRODUCT INFORMATION			
PRODUCT NUMBER: VOR-7516.0XXX	DATE: 12/03/10	SHEET NO: 1/1	11"x17" SHEET SIZE	




PLAN VIEW

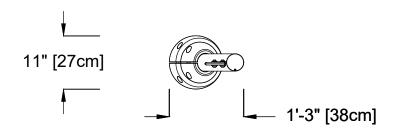

FRONT ELEVATION VIEW

SIDE ELEVATION VIEW

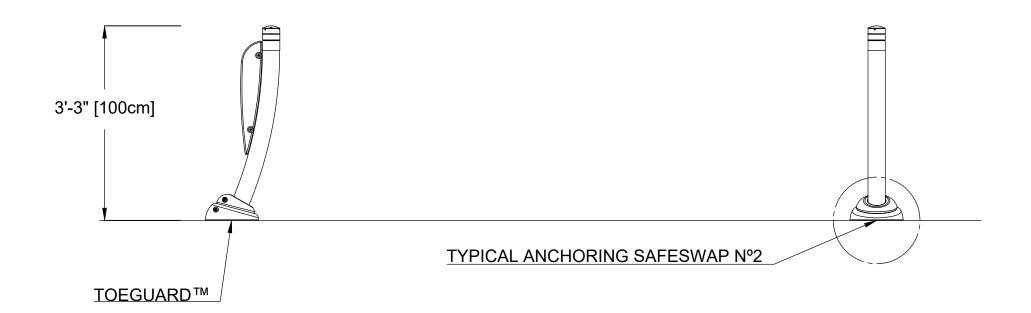

7799.2XXX SPIROO (Construction Detail)

PRODUCT NAME: SPIROO	PRODUCT INFORMATION			
PRODUCT NUMBER: 7799.2XXX	DATE: 02/28/20	SHEET NO: 1/1	11"x17" SHEET SIZE	



INSTALLATION DRAWING - DIMENSIONS FOR MAESTROPRO ENCLOSURES 33907.XXBX

NOTE:

1 - ENSURE ENOUGH CLEARANCE FOR THE DOOR OPENING

MAESTROPRO CONTROL MAESTROPRO POWER BOX **ENCLOSURE ENCLOSURE** SEE NOTE #1

MAESTROPRO ENCLOSURES DIMENSIONS

REFERENCE No.	DESCRIPTION	DIM "A"	DIM "B"	DIM "C"	DIM "D"	DIM "E"
33907.12B2	MAESTROPRO CTRL 24OUT/12IN 120VAC/240HZ	11.88"	11.88"	6.85"	11.08"	11.08"
33907.22B2	MAESTROPRO CTRL EXP 24OUT/12IN 120VAC/240HZ	11.88"	11.88"	6.85"	11.08"	11.08"
33907.13B0	MAESTROPRO POWERBOX 24OUT/12IN 120VAC/60HZ	12.308"	10.215"	5.57"	12.058"	9.965"
33907.13B1	MAESTROPRO POWERBOX 240UT/12IN 240VAC/50HZ	12.308"	10.215"	5.57"	12.058"	9.965"

REFER TO THE PIPING AND ELECTRICAL SHEET FOR THE CONTROLLER NUMBER

INSTALLATION DRAWING - DIMENSIONS FOR MAESTROPRO ENCLOSURES 33907.XXBX PRODUCT NAME:

PRODUCT NUMBER:

USE M5 SCREW (#10) TYP.

33907.XXBX

DATE: 04/06/20

SHEET NO: 1/3

11"x17" SHEET SIZE




INSTALLATION DRAWING - MAESTROPRO CTRL 33907.12B2 AND MAESTROPRO POWER BOX 33907.13BX CONNECTIONS

NOTE:


- 1 A MAXIMUM OF 1 ETHERNET CAT 5 CONNECTIONS IS AVAILABLE PER MAESTROPRO.

 IF MORE ETHERNET LAN CONNECTIONS ARE NEEDED. THEN IT REQUIRES AN ETHERNET SWITCH BOX (SOLD SEPARATELY).
- 2 FOR DIGITAL INPUT, 5-24 VDC SUPPLIED BY MAESTROPRO. REFER TO THE CORRESPONDING SCHEMATIC DRAWING MANUAL FOR WIRING DETAILS.
- 3 MAESTROPRO IS DHCP ADDRESSED BY CONNECTED LAN DEVICE.
- 4- WHEN USED WITH EXPANSION UNITS, AN ETHERNET CAT 5 CABLE IS REQUIRED BETWEEN EACH UNIT.
- 5- WATER TIGHT CONNECTIONS WITH MAESTROPRO DONE BY INSTALLER.
- 6- ALL WIRES AND CABLES ELECTRICAL CALCULATION ARE BY INSTALLER AND SHALL BE APPROVED ACCORDING TO LOCAL CODE AND BRAND NEW.

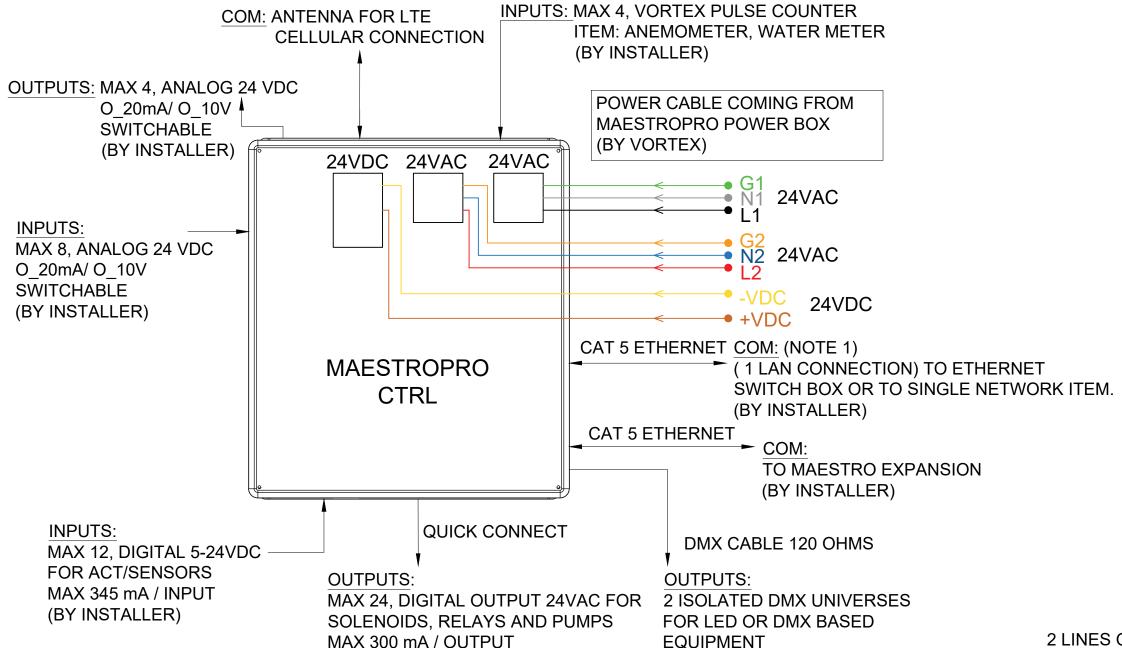

CIRCUIT BREAKER & FUSE	AMPS MAX	CIRCUIT
MAIN BREAKER; 3 AMPS	4 MAX	PRIMARY 120/240 VAC
FUSE 1; 5 AMPS	5 MAX	SECONDARY 24 VAC
FUSE 2; 5 AMPS	5 MAX	SECONDARY 24 VAC
FUSE 3; 5 AMPS	5 MAX	POWER SUPPLY 24 VDC



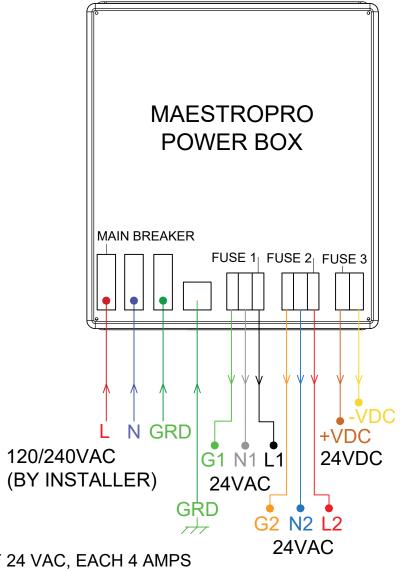

2 LINES OF 24 VAC, EACH 4 AMPS 1 LINE 24 VDC (V+, V-)

PRODUCT NAME: INSTALLATION DRAWING - MAESTROPRO CTRL 33907.X2BX AND MAESTROPRO POWER BOX 33907.13BX CONNECTIONS

PRODUCT NUMBER: 33907.XXBX

DATE: 05/04/20


SHEET NO: 2/3

11"x17" SHEET SIZE

% VORTEX

(BY INSTALLER)

INSTALLATION DRAWING - MAESTROPRO EXPANSION UNIT 33907.22B2 AND MAESTROPRO POWER BOX 33907.13BX CONNECTIONS

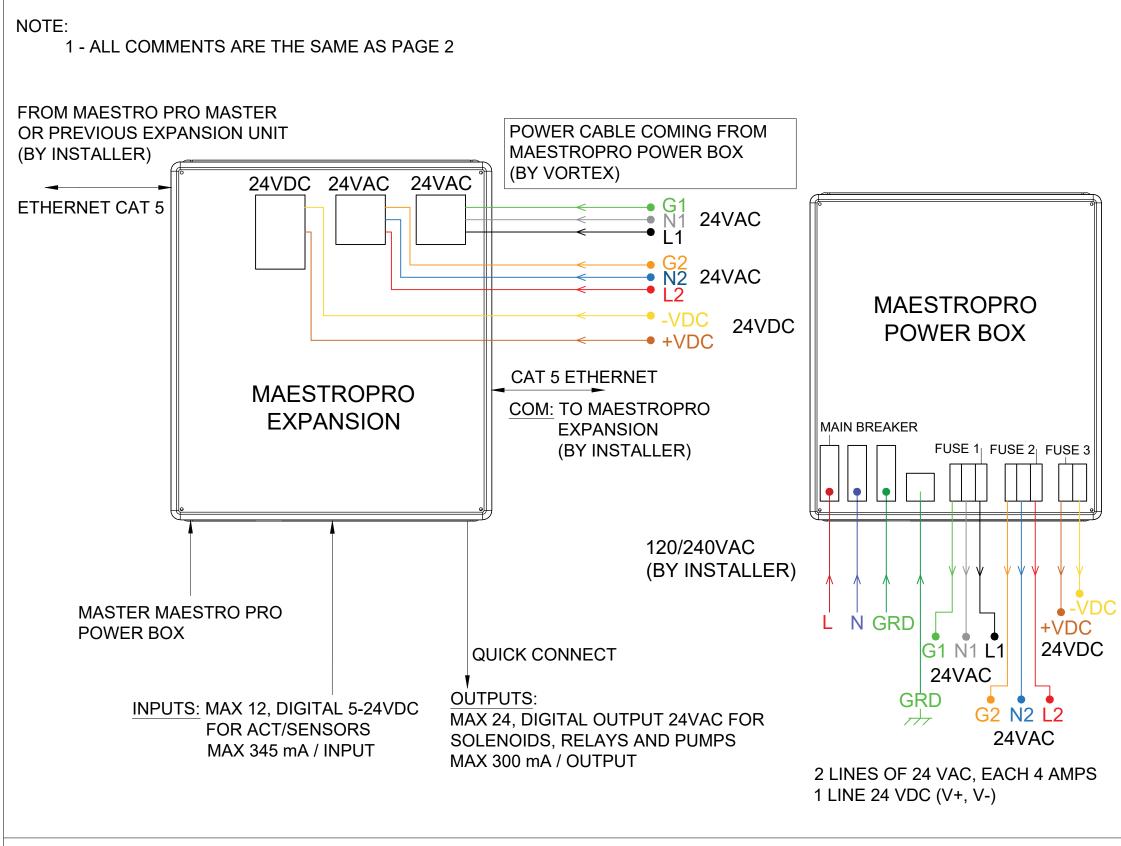

DIP SWITCH OPTIONS:				
BIT 3 BIT 2	0	1 1		
BIT 1	0	1		
EXPANSION 1:	BIT 1_0	BIT 2_0	BIT 3_1	
EXPANSION 2:	BIT 1_0	BIT 2_1	BIT 3_0	
EXPANSION 3:	BIT 1_0	BIT 2_1	BIT 3_1	
EXPANSION 4:	BIT 1_1	BIT 2_0	BIT 3_0	


CIRCUIT BREAKER & FUSE	AMPS MAX	CIRCUIT
MAIN BREAKER; 3 AMPS	4 MAX	PRIMARY 120/240 VAC
FUSE 1; 5 AMPS	5 MAX	SECONDARY 24 VAC
FUSE 2; 5 AMPS	5 MAX	SECONDARY 24 VAC
FUSE 3; 5 AMPS	5 MAX	POWER SUPPLY 24 VDC

— L1 (LINE) — L2 (LINE) — G1 (GROUND) — G2 (GROUND)

PRODUCT NAME: INSTALLATION DRAWING - MAESTROPRO EXPANSION UNIT 33907.X2BX AND MAESTROPRO POWER BOX 33907.13BX CONNECTIONS


PRODUCT NUMBER: 33907.XXBX DATE: 05/04/20 SHEET NO: 3/3 11"x17" SHEET SIZE



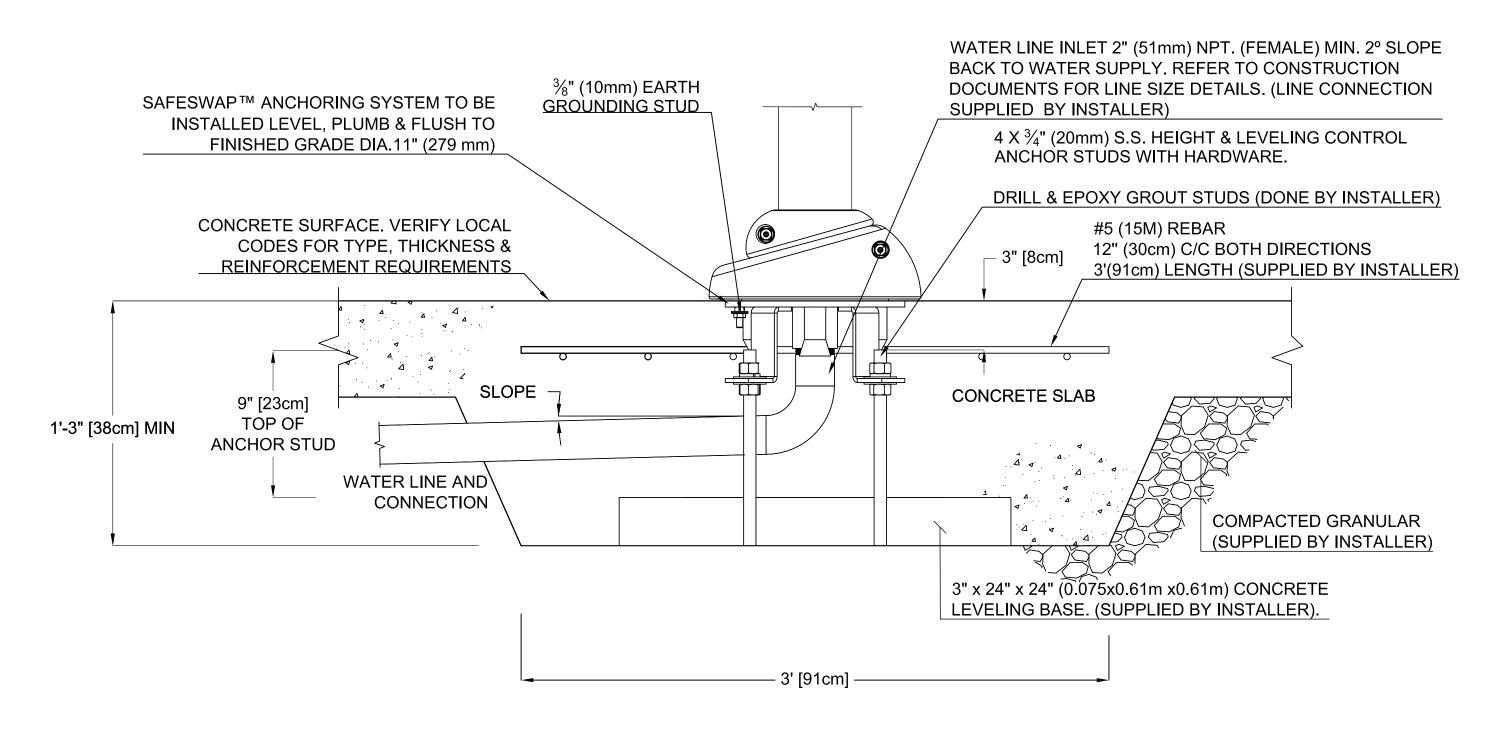

SAFESWAP N° 1 (Construction Detail) LARGE

PRODUCT NAME: SAFESWAP N°1	PRODUCT INFORMATION			2 N/005
PRODUCT NUMBER: 55000.0430	DATE: 04/06/12	SHEET NO: 1/1	11"x17" SHEET SIZE	S. VUR

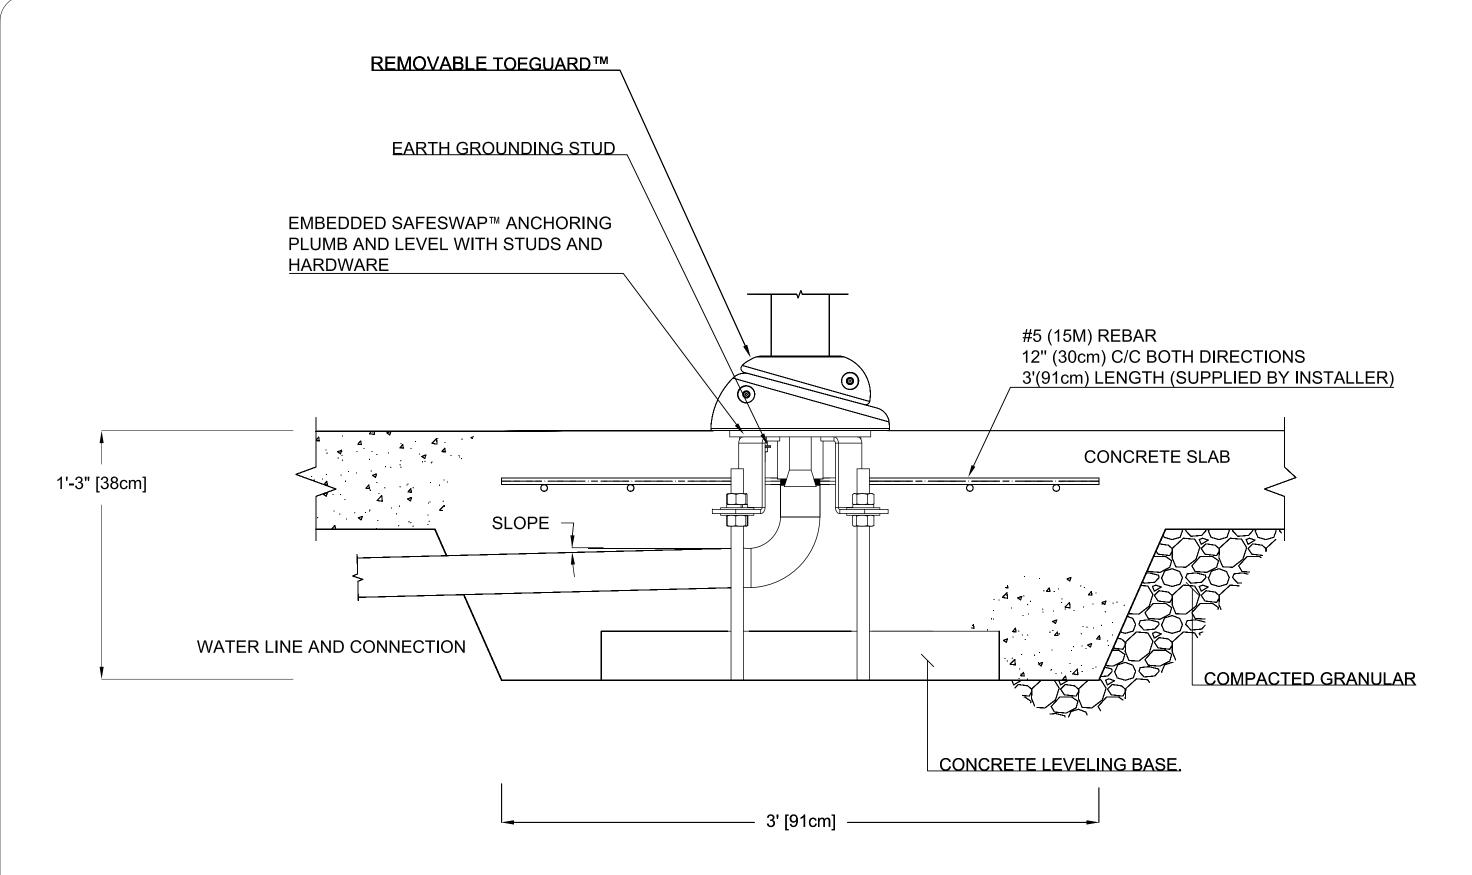

VOR-55000-0570 SAFESWAP N°2 MEDIUM (Typical Detail)

PRODUCT NAME: SAFESWAP N°2 MEDIUM	PRODUCT INFORMATION		2 1/05	
PRODUCT NUMBER: VOR-55000-0570	DATE: 05/30/23	SHEET NO: 1/1	11"x17" SHEET SIZE	I GJ VORI